BID DOCUMENTS Ramsdell Library Great Barrington, Massachusetts

May 30, 2010

Prepared for:

Town of Great Barrington 334 Main Street Great Barrington, MA 01230

Ramsdell Library 1087 Main Street Housatonic Great Barrington, MA 01230 **Anne Just** Director

Administered By:

Funded By:

This project is funded in part by the Community Development Block Grant, and the Town of Great Barrington



Existing Library Front Facade

Sheet Index:

- L0 Site Survey
- L1 Demolition Plan
- Layout Plan
- L3 Grading & Drainage Plan
- L4 Details

Prepared by:





Landscape Architecture Civil Engineering Planning Urban Design Environmental Design


4 Allen Place, Northampton, Massachusetts 01060 Tel (413) 582-7000 • FAX (413) 582-7005


FOR REVIEW ONLY 11-17-23

BID SET

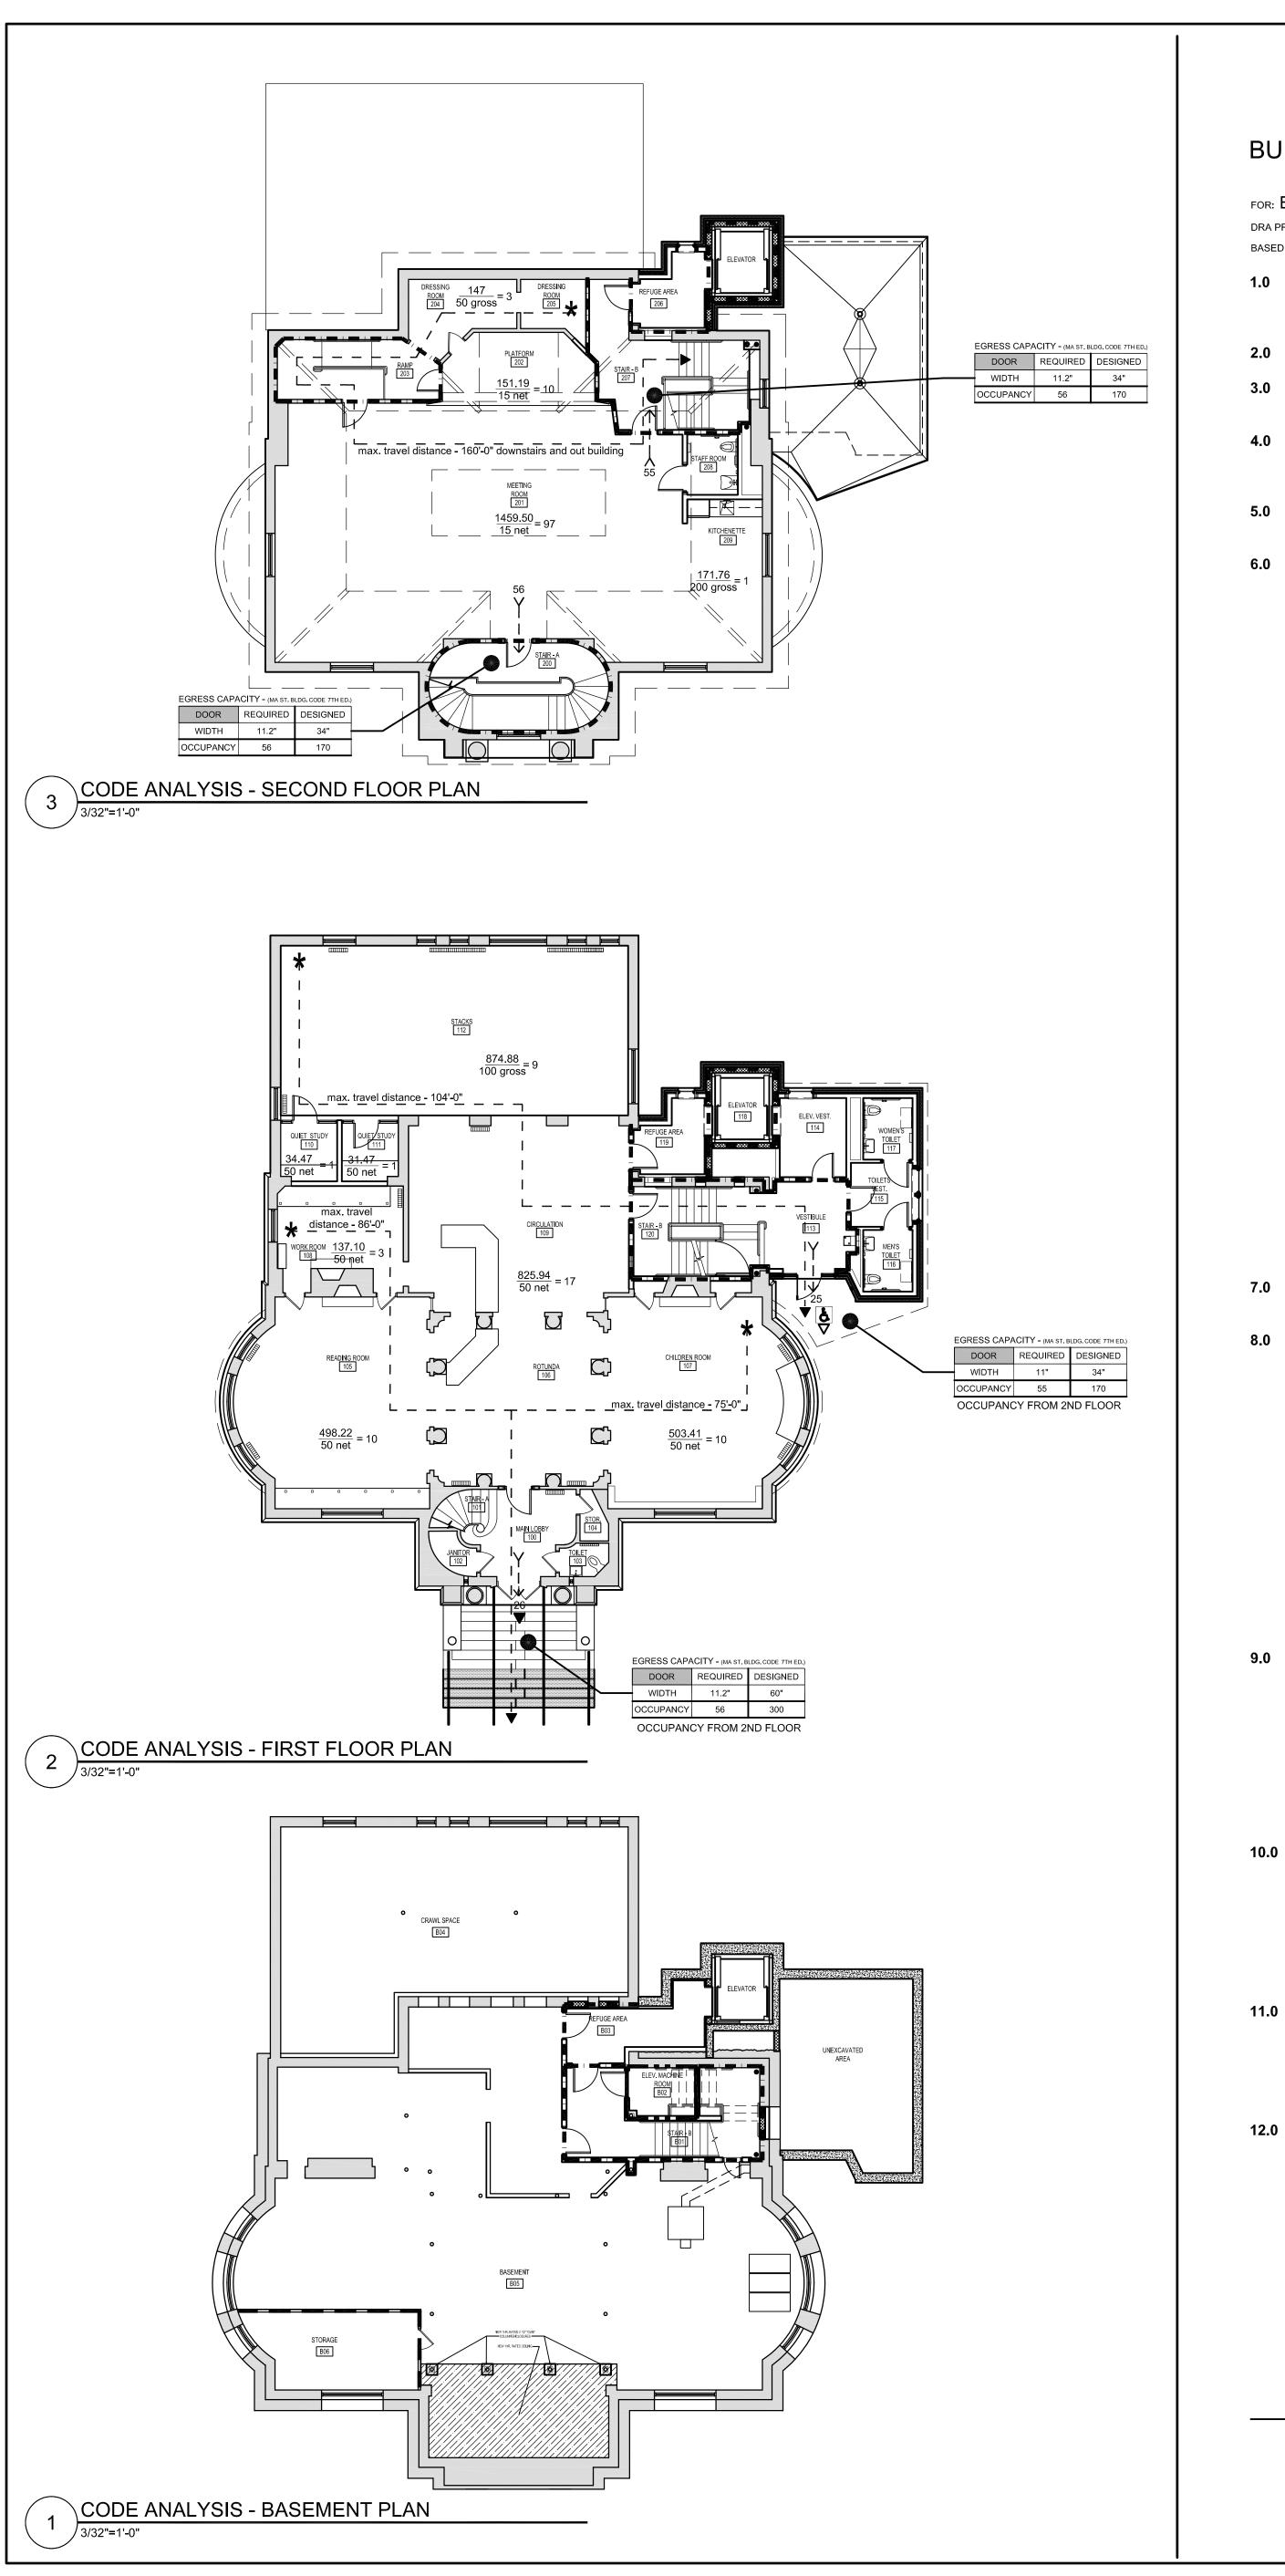

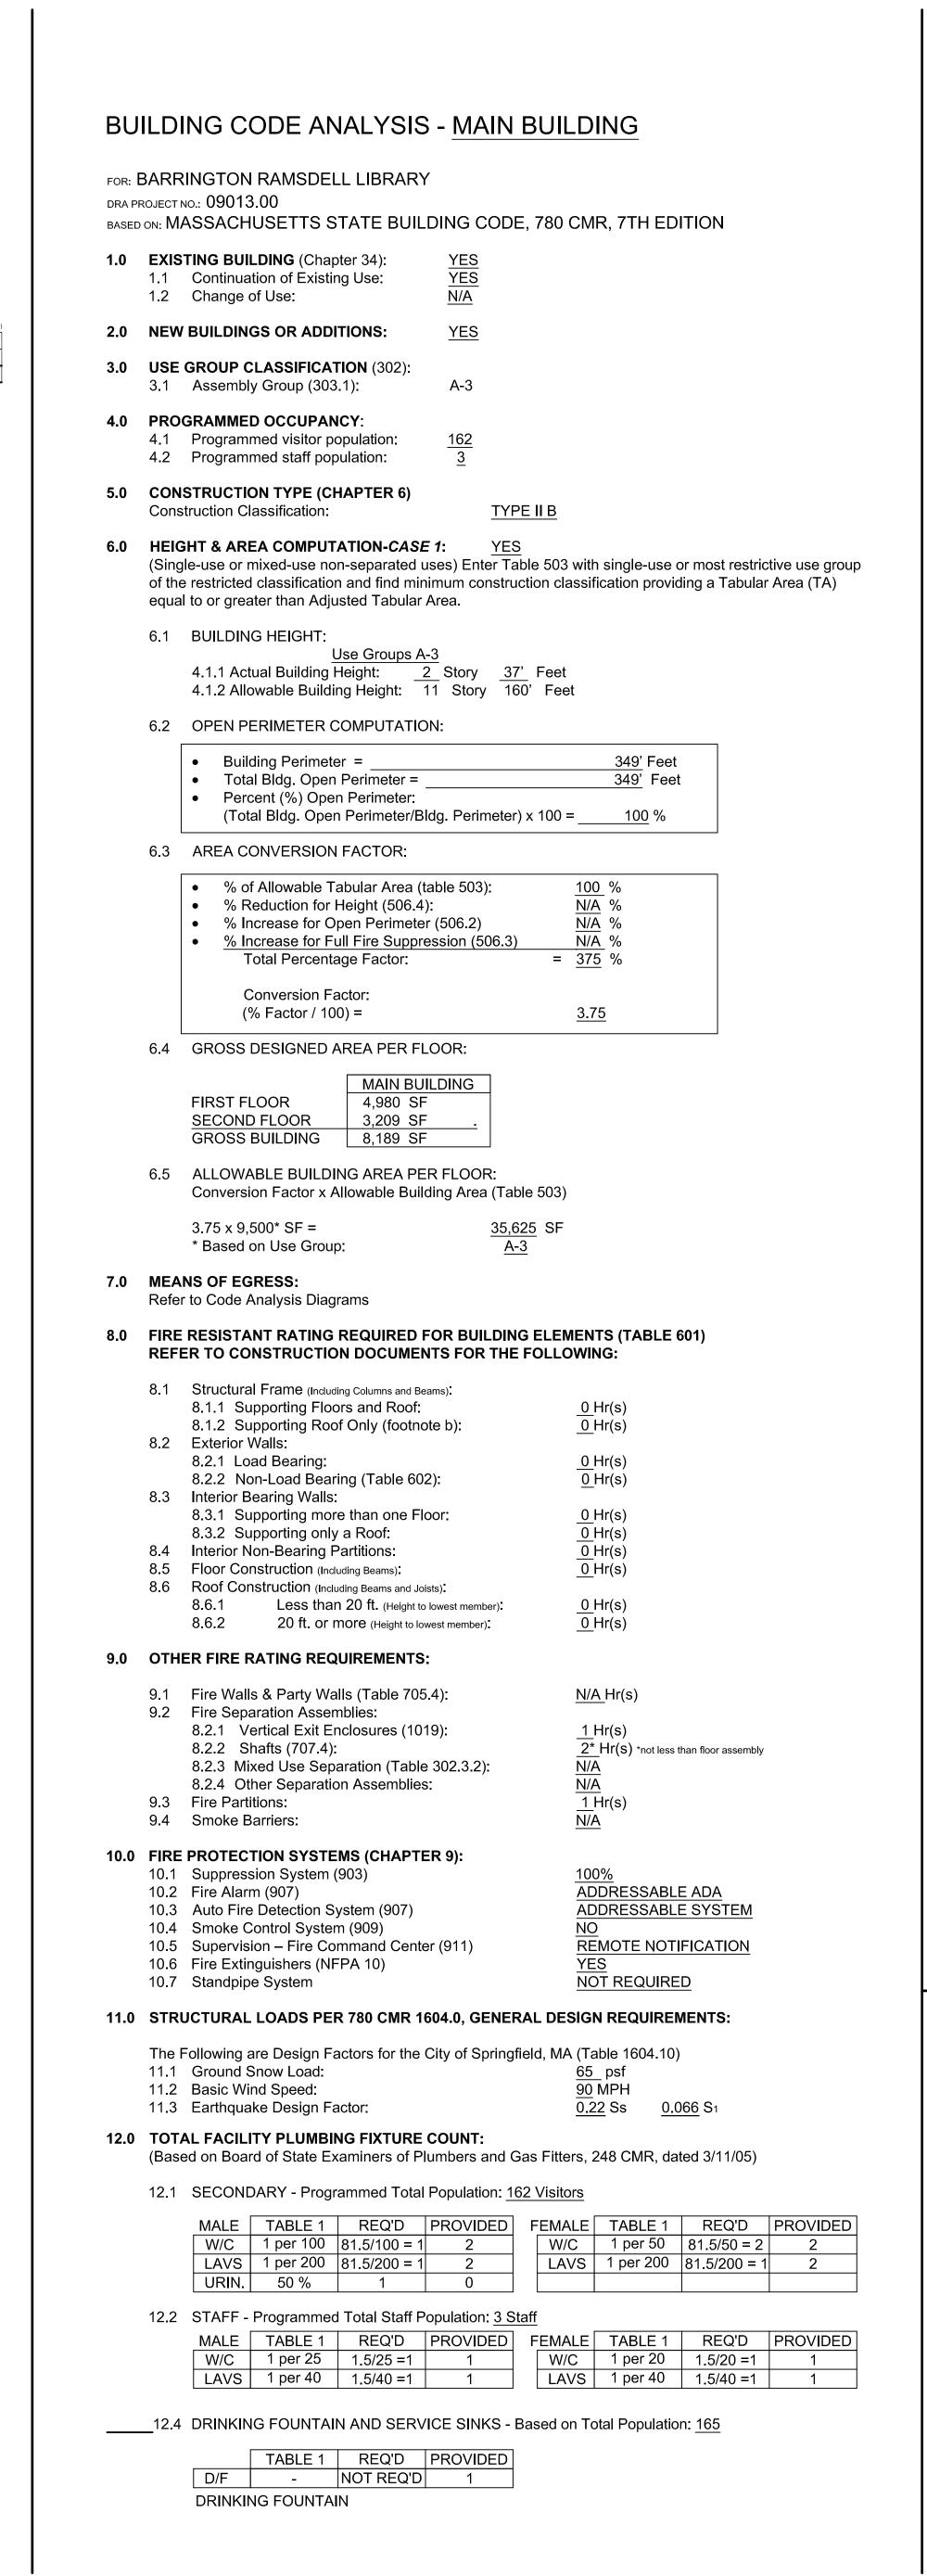

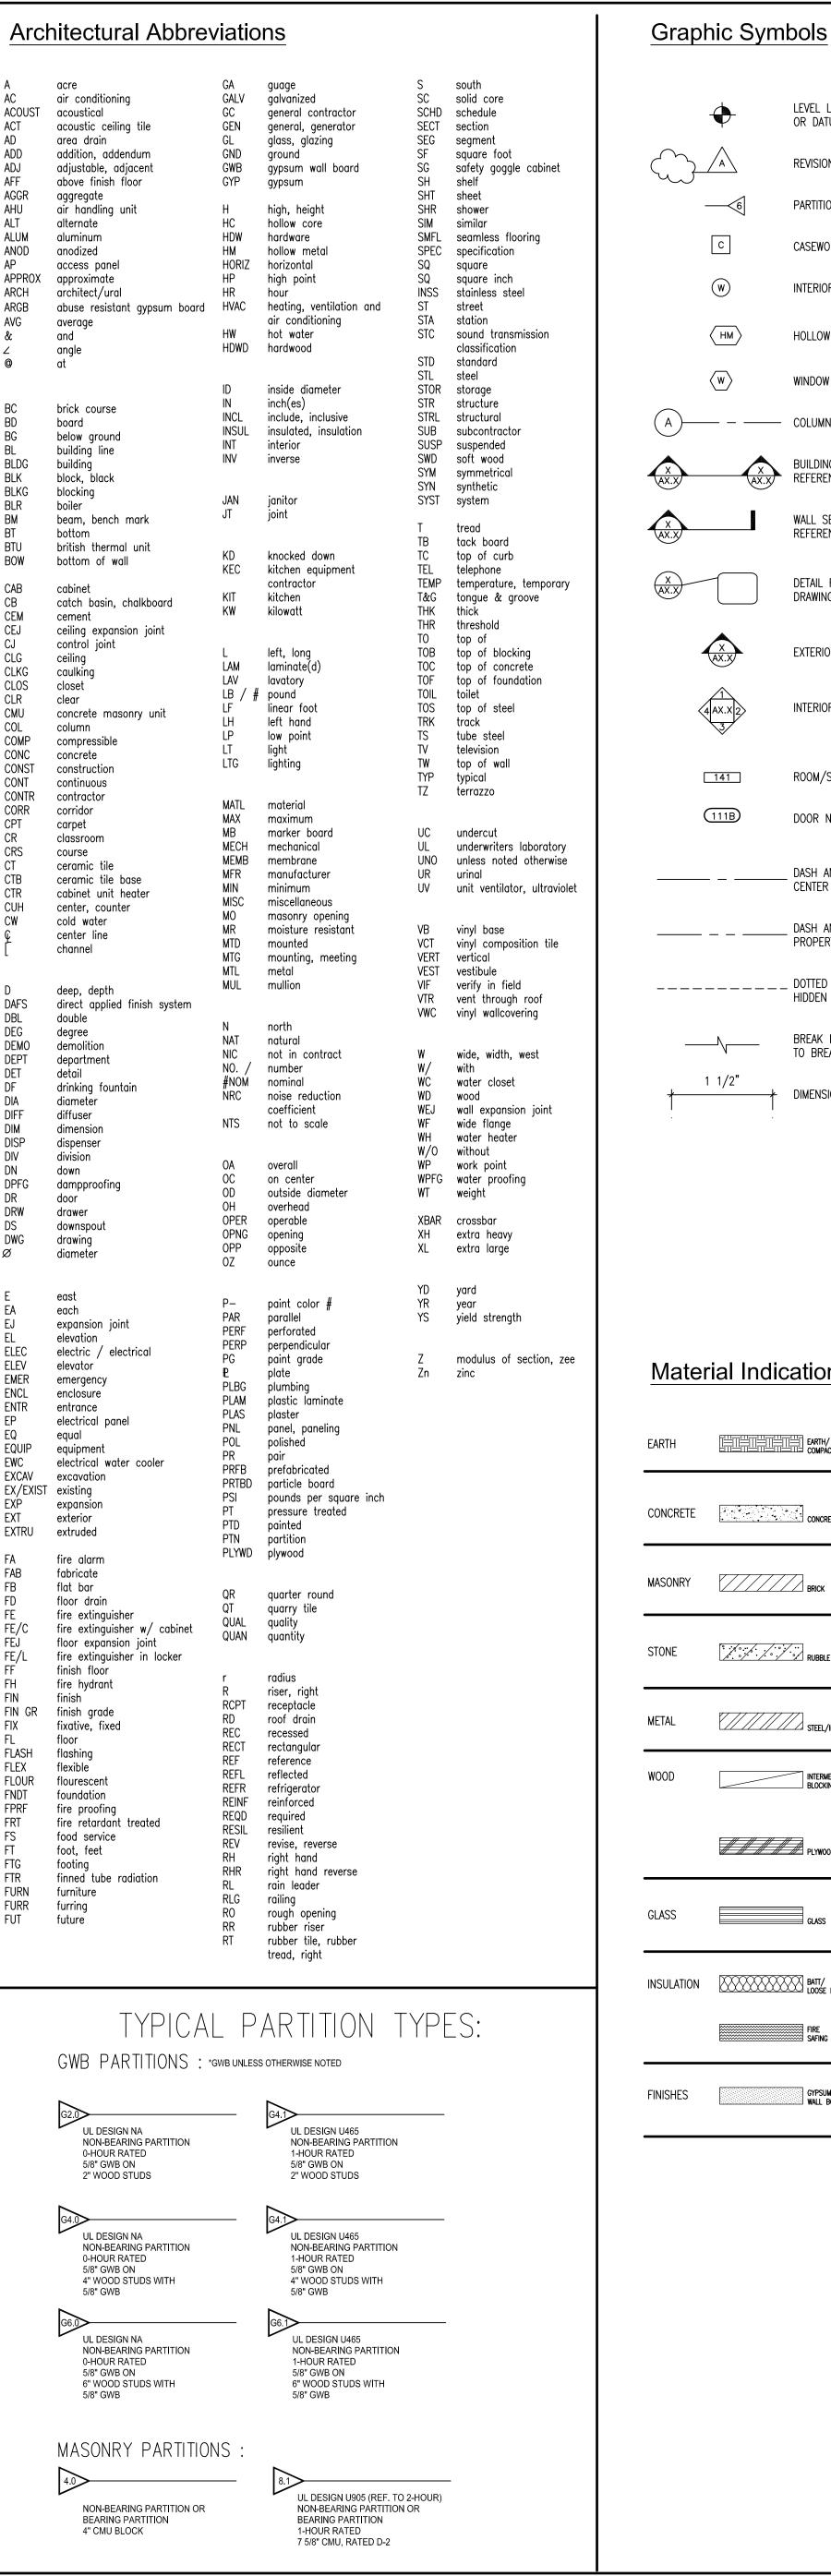

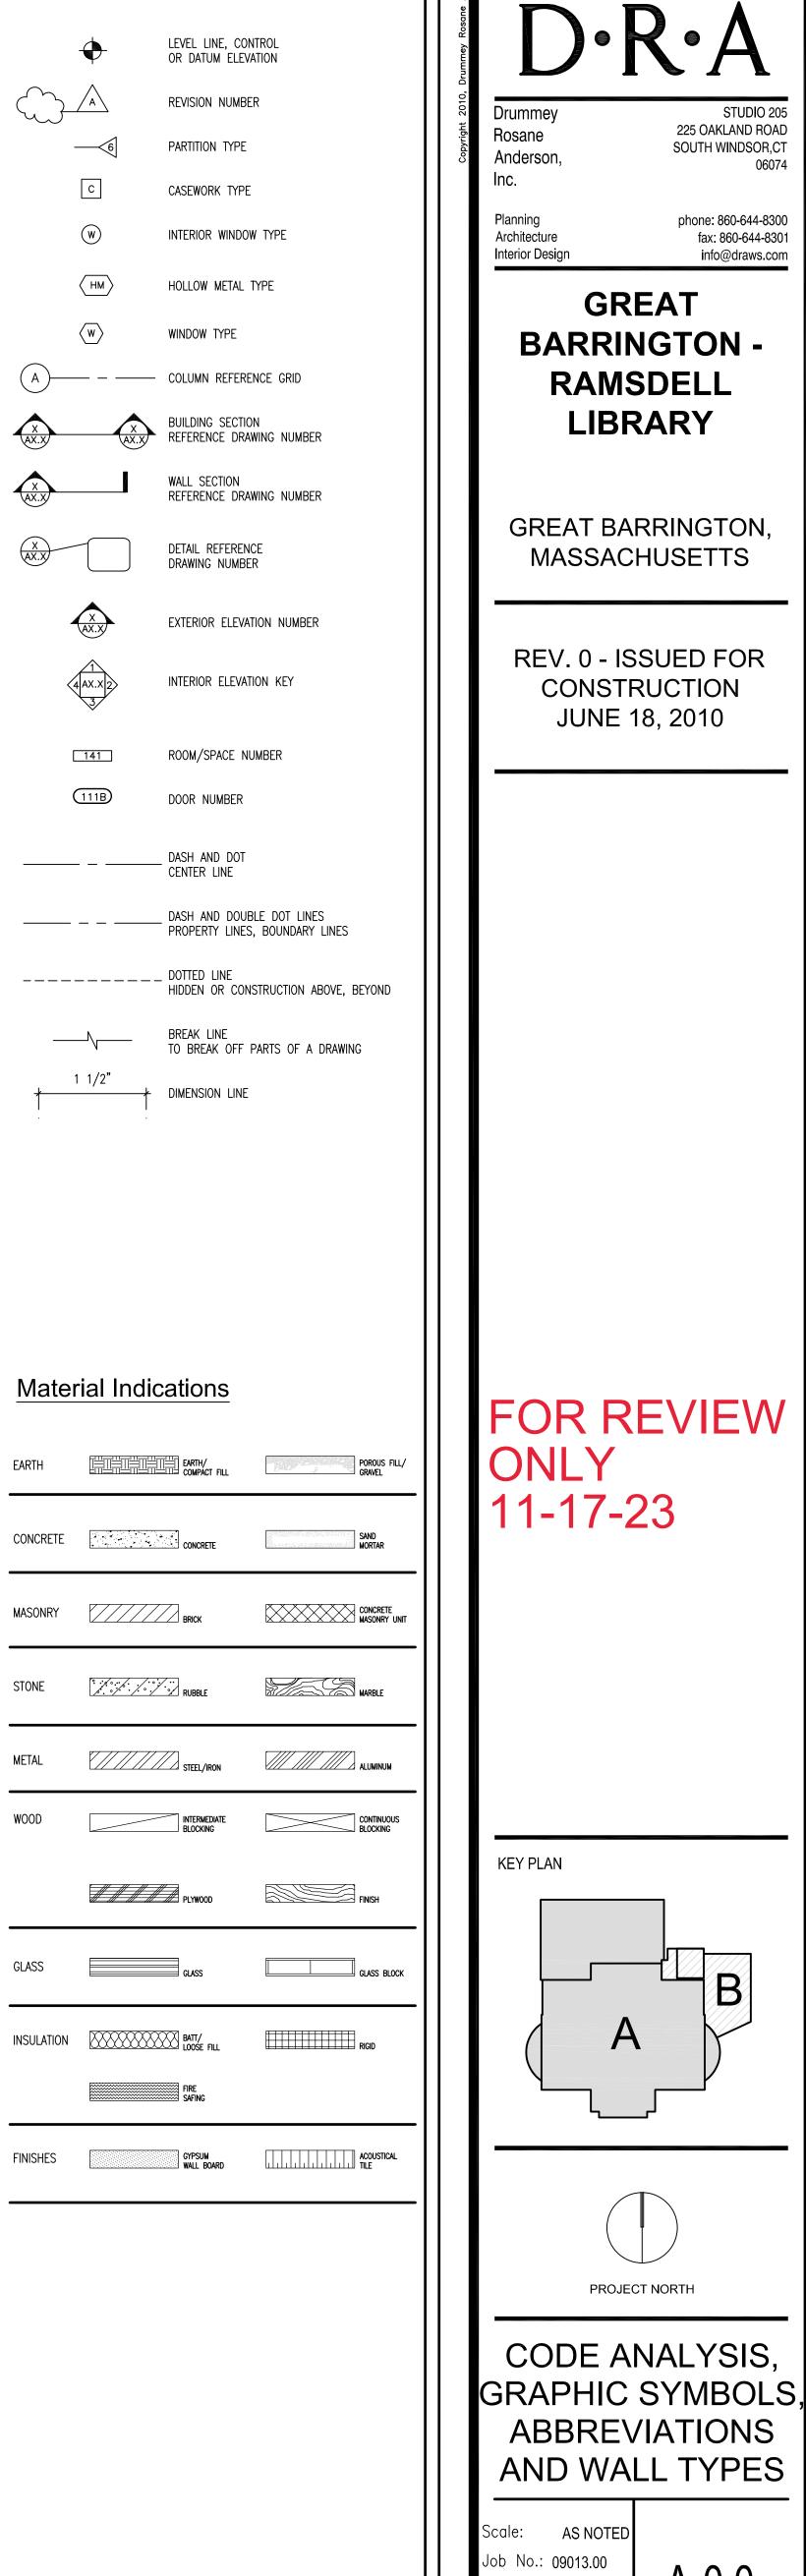

225 OAKLAND ROAD

SOUTH WINDSOR,CT

phone: 860-644-8300

GREAT

PROJECT NORTH


Drawn by: DRA

Date: June 18, 2010

A-0.0

fax: 860-644-8301

info@draws.com

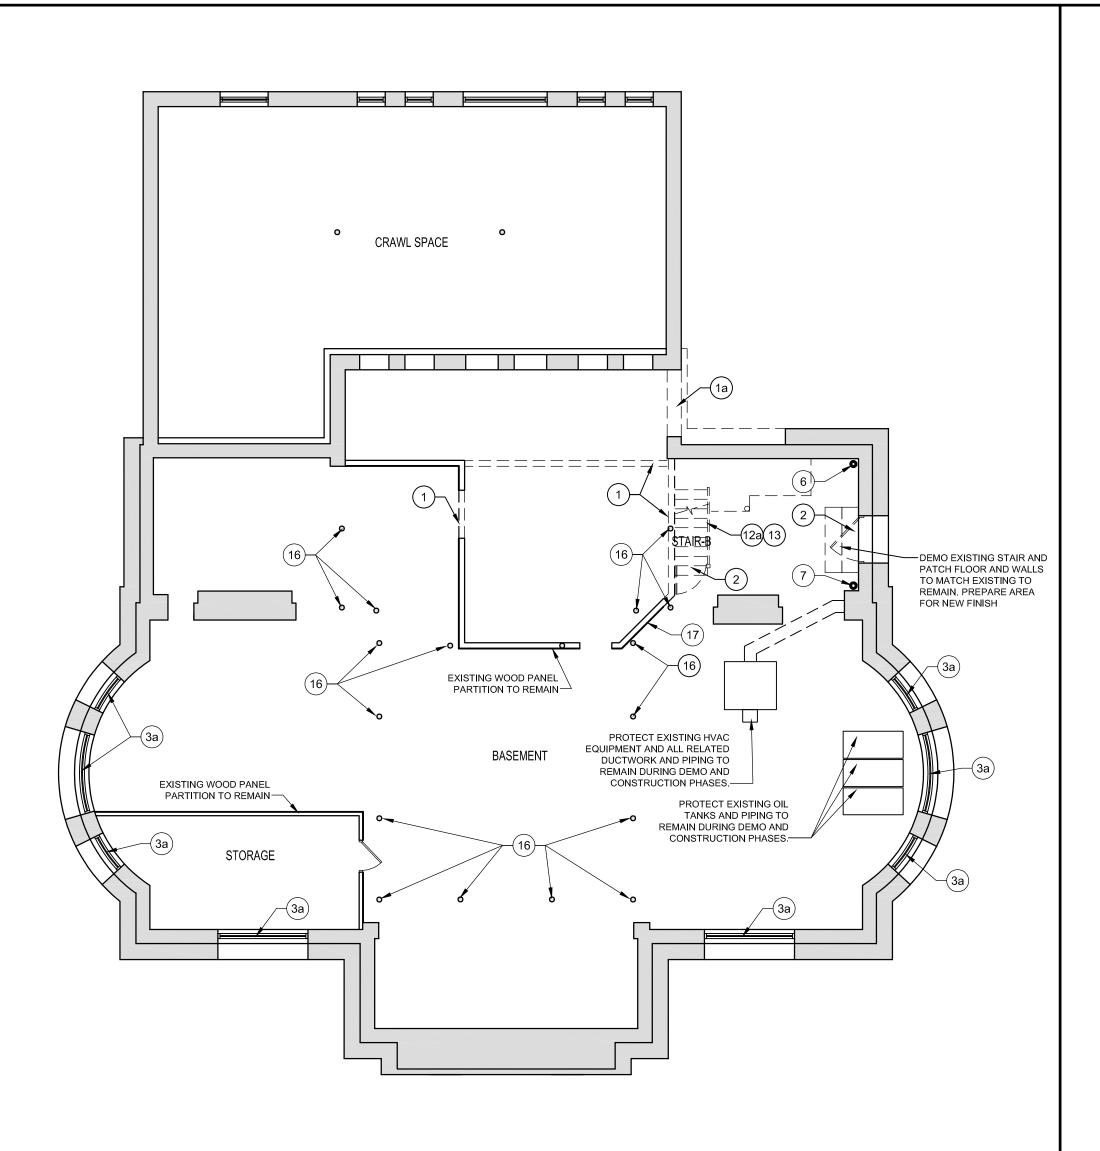

LEGEND DEMO NOTES:

1. REMOVE EXISTING WOOD OR METAL PARTITION(S). PATCH FLOOR, WALLS AND CEILING TO MATCH EXISTING TO REMAIN. PREPARE AREA FOR NEW FINISH.

\DEMOLITION BASEMENT FLOOR PLAN

1a. REMOVE EXTERIOR MASONRY WALL AND ASSOCIATED ELEMENTS. PATCH FLOOR AND WALLS TO MACH EXISTING TO REMAIN. ALLOW MASONRY UNITS TO BE EITHER TOOTHED OR SAW CUT AS REQUIRED FOR NEW WORK. PREPARE AREA FOR NEW FINISH.

2. REMOVE DOOR(S), FRAMES, INCLUDING TRANSOM PANEL(S), BLOCKING TRIM AND THRESHOLD WHERE EXISTING. EXPOSED ROUGH OPENING. PREPARE AREA FOR NEW FINISH.

2a. PROTECT EXISTING DOOR, HARDWARE AND ALL ASSOCIATED ELEMENTS TO REMAIN DURING DEMOLITION AND CONSTRUCTION

3. REMOVE EXISTING WINDOW UNIT(S) WITH FRAMES, ASSOCIATED WOOD BLOCKING, AND WINDOW TREATMENTS WHERE EXISTING AS REQUIRED FOR NEW FINISH.

3a. PROTECT EXISTING WINDOW(S) AND ALL ASSOCIATED ELEMENTS TO REMAIN DURING DEMOLITION AND CONSTRUCTION PHASES.

4. PROTECT EXISTING RADIATOR(S) TO REMAIN DURING DEMOLITION AND CONSTRUCTION PHASES. 5. REMOVE EXISTING PLUMBING FIXTURES AND LINES BACK TO A POINT

WHICH WOULD NOT INTERFERE WITH NEW WORK. CAP PLUMBING LINES. REFER TO PLUMBING DRAWINGS FOR ADDITIONAL INFORMATION. 5a. PROTECT PLUMBING FIXTURES AND TOILET ACCESSORIES TO

6. PROTECT EXISTING RAIN LEADER. REFER TO PLUMBING DRAWINGS FOR ADDITIONAL INFORMATION.

7. PROTECT EXISTING SEWER(S) PIPE. REFER TO PLUMBING DRAWINGS FOR ADDITIONAL INFORMATION.

8. REMOVE EXISTING CASEWORK, BUILT-IN SHELVING, TACKBOARDS, COUNTERTOP.

8a. REMOVE AND PROTECT EXISTING RECEPTION DESK. TURN OVER TO

9. PROTECT EXISTING FIREPLACE, WOOD MANTEL AND ALL ASSOCIATED ELEMENTS TO REMAIN DURING DEMO AND CONSTRUCTION PHASES.

10. PROTECT EXISTING MARBLE COLUMN(S), ALL ASSOCIATED ELEMENTS AND WOOD TRIMS TO REMAIN DURING DEMO AND CONSTRUCTION PHASES.

11. REMOVE WALL COVERINGS FROM EXISTING MARBLE COLUMN(S) AND ALL ASSOCIATED ELEMENTS. RE-FINISH TO MATCH EXISTING. PROTECT COLUMN(S) AND WOOD TRIMS TO REMAIN DURING DEMO AND CONSTRUCTION PHASES.

12. REMOVE AND SALVAGE WOOD FLOOR TO BE RE-INSTALL WHERE PARTITION WALLS WERE REMOVED. REFER TO STRUCTURAL DRAWINGS FOR COORDINATION OF NEW STAIR.

12a. REMOVE ALL EXISTING FINISH CEILING MATERIAL, LIGHT FIXTURES AND DUCTWORK WHERE EXISTING. REFER TO 'MEP' DRAWINGS.


13. REMOVE EXISTING WOODEN STAIR, PILASTERS, HANDRAILS AND BASE. PREPARE AREA FOR NEW WORK. REFER TO STRUCTURAL

14. PROTECT EXISTING WOODEN STAIR, PILASTERS, HANDRAILS AND BASE TO REMAIN. <u>NO CONTRACTOR ARE ALLOW TO USE STAIR DURING</u> DEMO AND CONSTRUCTION PHASES.

15. PROTECT EXISTING STAGE FLOOR DURING DEMO AND CONSTRUCTION PHASES.

16. PROTECT EXISTING COLUMNS TO REMAIN. REFER TO STRUCTURAL DRAWINGS.

17. PROTECT EXISTING ELECTRICAL PANELS AND RELATED COMPONENTS. REFER TO ELECTRICAL DRAWINGS.

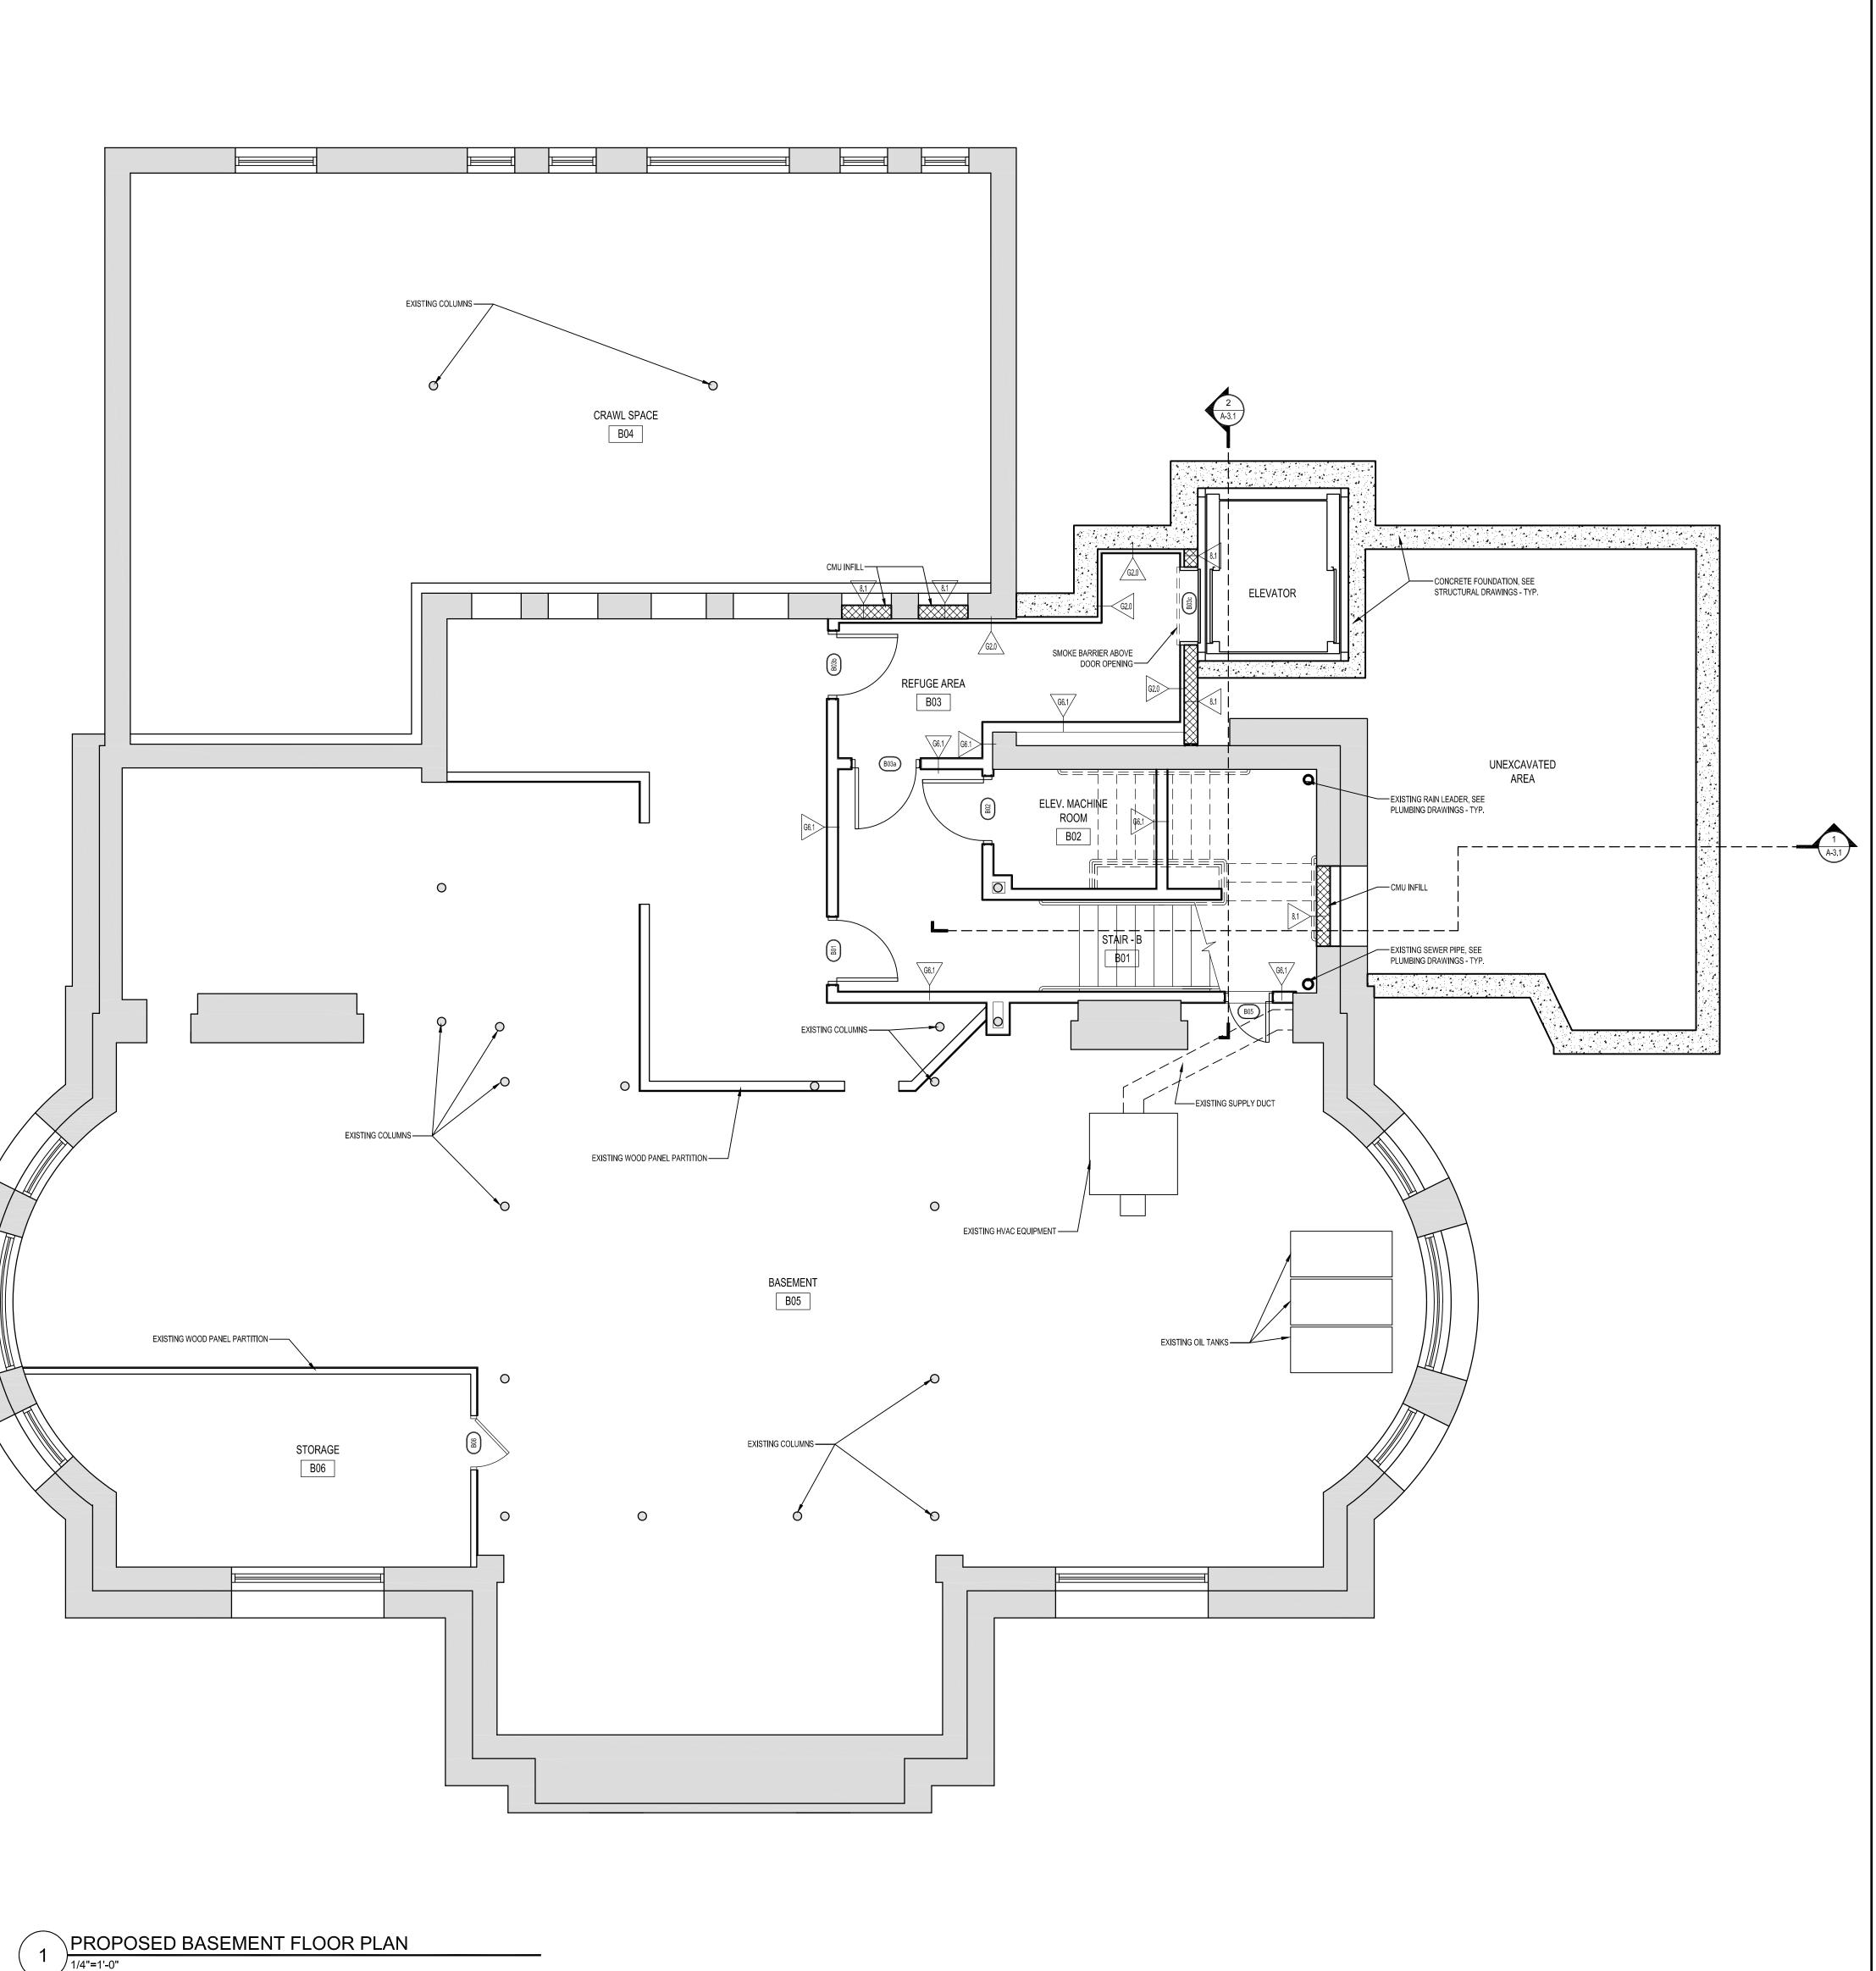



Rosane Anderson,

Architecture

phone: 860-644-8300 fax: 860-644-8301 Interior Design info@draws.com

225 OAKLAND ROAD

SOUTH WINDSOR,CT

GREAT BARRINGTON -RAMSDELL LIBRARY


GREAT BARRINGTON, MASSACHUSETTS

PROGRESS PRINT May 25.10

NOT FOR CONSTRUCTION

FOR REVIEW

KEY PLAN

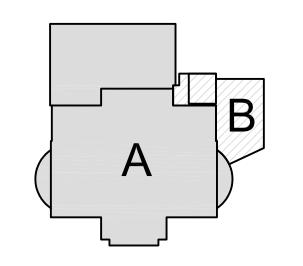




BASEMENT **FLOOR**

PLANS

Scale: AS NOTED Job No.: 09013.00 Drawn by: DRA

Date: May 25, 2010

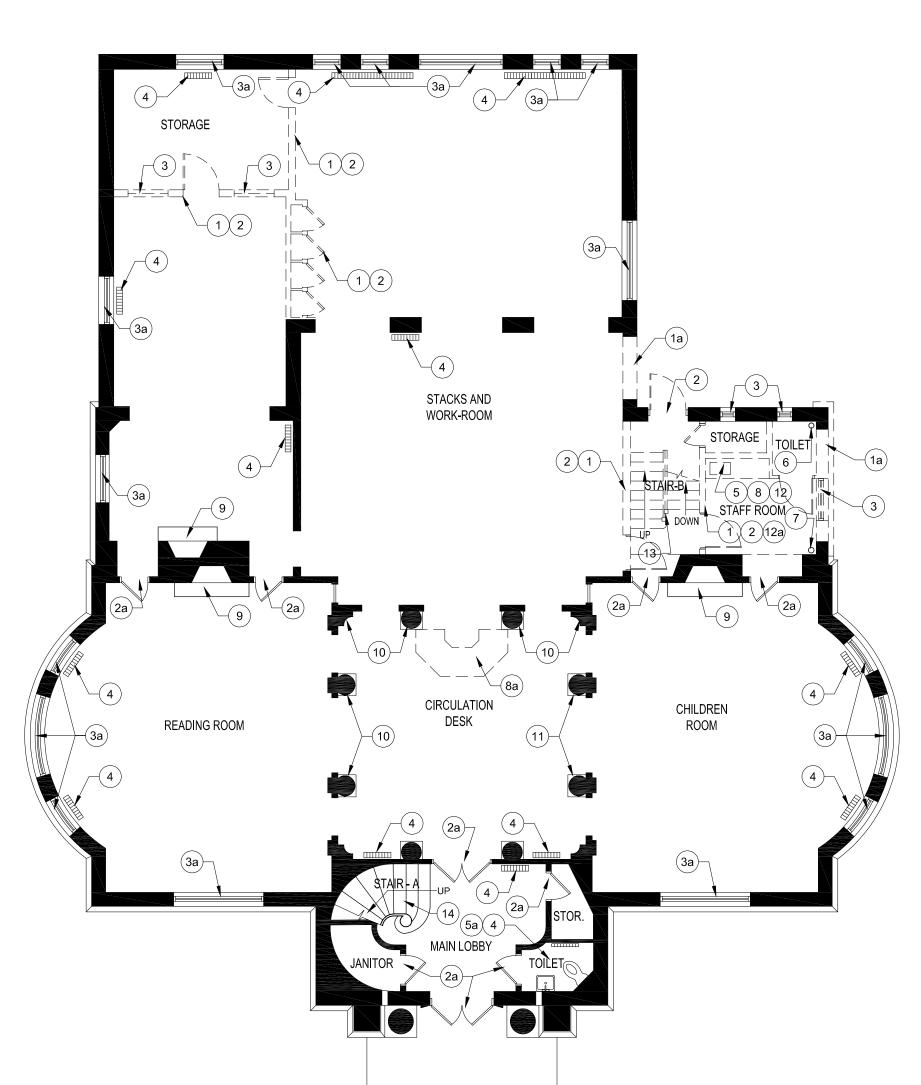

LEGEND DEMO NOTES:

1. REMOVE EXISTING WOOD OR METAL PARTITION(S). PATCH FLOOR, WALLS AND CEILING TO MATCH EXISTING TO REMAIN. PREPARE AREA FOR NEW FINISH.

3 DEMOLITION FIRST FLOOR PLAN
1/8"=1'-0"

1a. REMOVE EXTERIOR MASONRY WALL AND ASSOCIATED ELEMENTS. PATCH FLOOR AND WALLS TO MACH EXISTING TO REMAIN. ALLOW MASONRY UNITS TO BE EITHER TOOTHED OR SAW CUT AS REQUIRED FOR NEW WORK. PREPARE AREA FOR NEW FINISH.

2. REMOVE DOOR(S), FRAMES, INCLUDING TRANSOM PANEL(S), BLOCKING TRIM AND THRESHOLD WHERE EXISTING. EXPOSED ROUGH OPENING. PREPARE AREA FOR NEW FINISH.

ELEMENTS TO REMAIN DURING DEMOLITION AND CONSTRUCTION

2a. PROTECT EXISTING DOOR, HARDWARE AND ALL ASSOCIATED

3. REMOVE EXISTING WINDOW UNIT(S) WITH FRAMES, ASSOCIATED WOOD BLOCKING, AND WINDOW TREATMENTS WHERE EXISTING AS REQUIRED FOR NEW FINISH.

3a. PROTECT EXISTING WINDOW(S) AND ALL ASSOCIATED ELEMENTS TO REMAIN DURING DEMOLITION AND CONSTRUCTION PHASES.

4. PROTECT EXISTING RADIATOR(S) TO REMAIN DURING DEMOLITION AND CONSTRUCTION PHASES.

5. REMOVE EXISTING PLUMBING FIXTURES AND LINES BACK TO A POINT WHICH WOULD NOT INTERFERE WITH NEW WORK. CAP PLUMBING LINES. REFER TO PLUMBING DRAWINGS FOR ADDITIONAL INFORMATION.

5a. PROTECT PLUMBING FIXTURES AND TOILET ACCESSORIES TO

6. PROTECT EXISTING RAIN LEADER. REFER TO PLUMBING DRAWINGS FOR ADDITIONAL INFORMATION.

7. PROTECT EXISTING SEWER(S) PIPE. REFER TO PLUMBING DRAWINGS FOR ADDITIONAL INFORMATION.

8. REMOVE EXISTING CASEWORK, BUILT-IN SHELVING, TACKBOARDS, COUNTERTOP.

8a. REMOVE AND PROTECT EXISTING RECEPTION DESK. TURN OVER TO THE OWNER.

9. PROTECT EXISTING FIREPLACE, WOOD MANTEL AND ALL ASSOCIATED ELEMENTS TO REMAIN DURING DEMO AND CONSTRUCTION PHASES.

10. PROTECT EXISTING MARBLE COLUMN(S), ALL ASSOCIATED ELEMENTS AND WOOD TRIMS TO REMAIN DURING DEMO AND CONSTRUCTION PHASES.

11. REMOVE WALL COVERINGS FROM EXISTING MARBLE COLUMN(S) AND ALL ASSOCIATED ELEMENTS. RE-FINISH TO MATCH EXISTING. PROTECT COLUMN(S) AND WOOD TRIMS TO REMAIN DURING DEMO AND CONSTRUCTION PHASES.

12. REMOVE AND SALVAGE WOOD FLOOR TO BE RE-INSTALL WHERE PARTITION WALLS WERE REMOVED. REFER TO STRUCTURAL DRAWINGS FOR COORDINATION OF NEW STAIR.

12a. REMOVE ALL EXISTING FINISH CEILING MATERIAL, LIGHT FIXTURES AND DUCTWORK WHERE EXISTING. REFER TO 'MEP' DRAWINGS.

13. REMOVE EXISTING WOODEN STAIR, PILASTERS, HANDRAILS AND BASE. PREPARE AREA FOR NEW WORK. REFER TO STRUCTURAL


14. PROTECT EXISTING WOODEN STAIR, PILASTERS, HANDRAILS AND BASE TO REMAIN. NO CONTRACTOR ARE ALLOW TO USE STAIR DURING DEMO AND CONSTRUCTION PHASES.

16. PROTECT EXISTING COLUMNS TO REMAIN. REFER TO STRUCTURAL

15. PROTECT EXISTING STAGE FLOOR DURING DEMO AND CONSTRUCTION PHASES.

17. PROTECT EXISTING ELECTRICAL PANELS AND RELATED COMPONENTS. REFER TO ELECTRICAL DRAWINGS.

DRAWINGS.

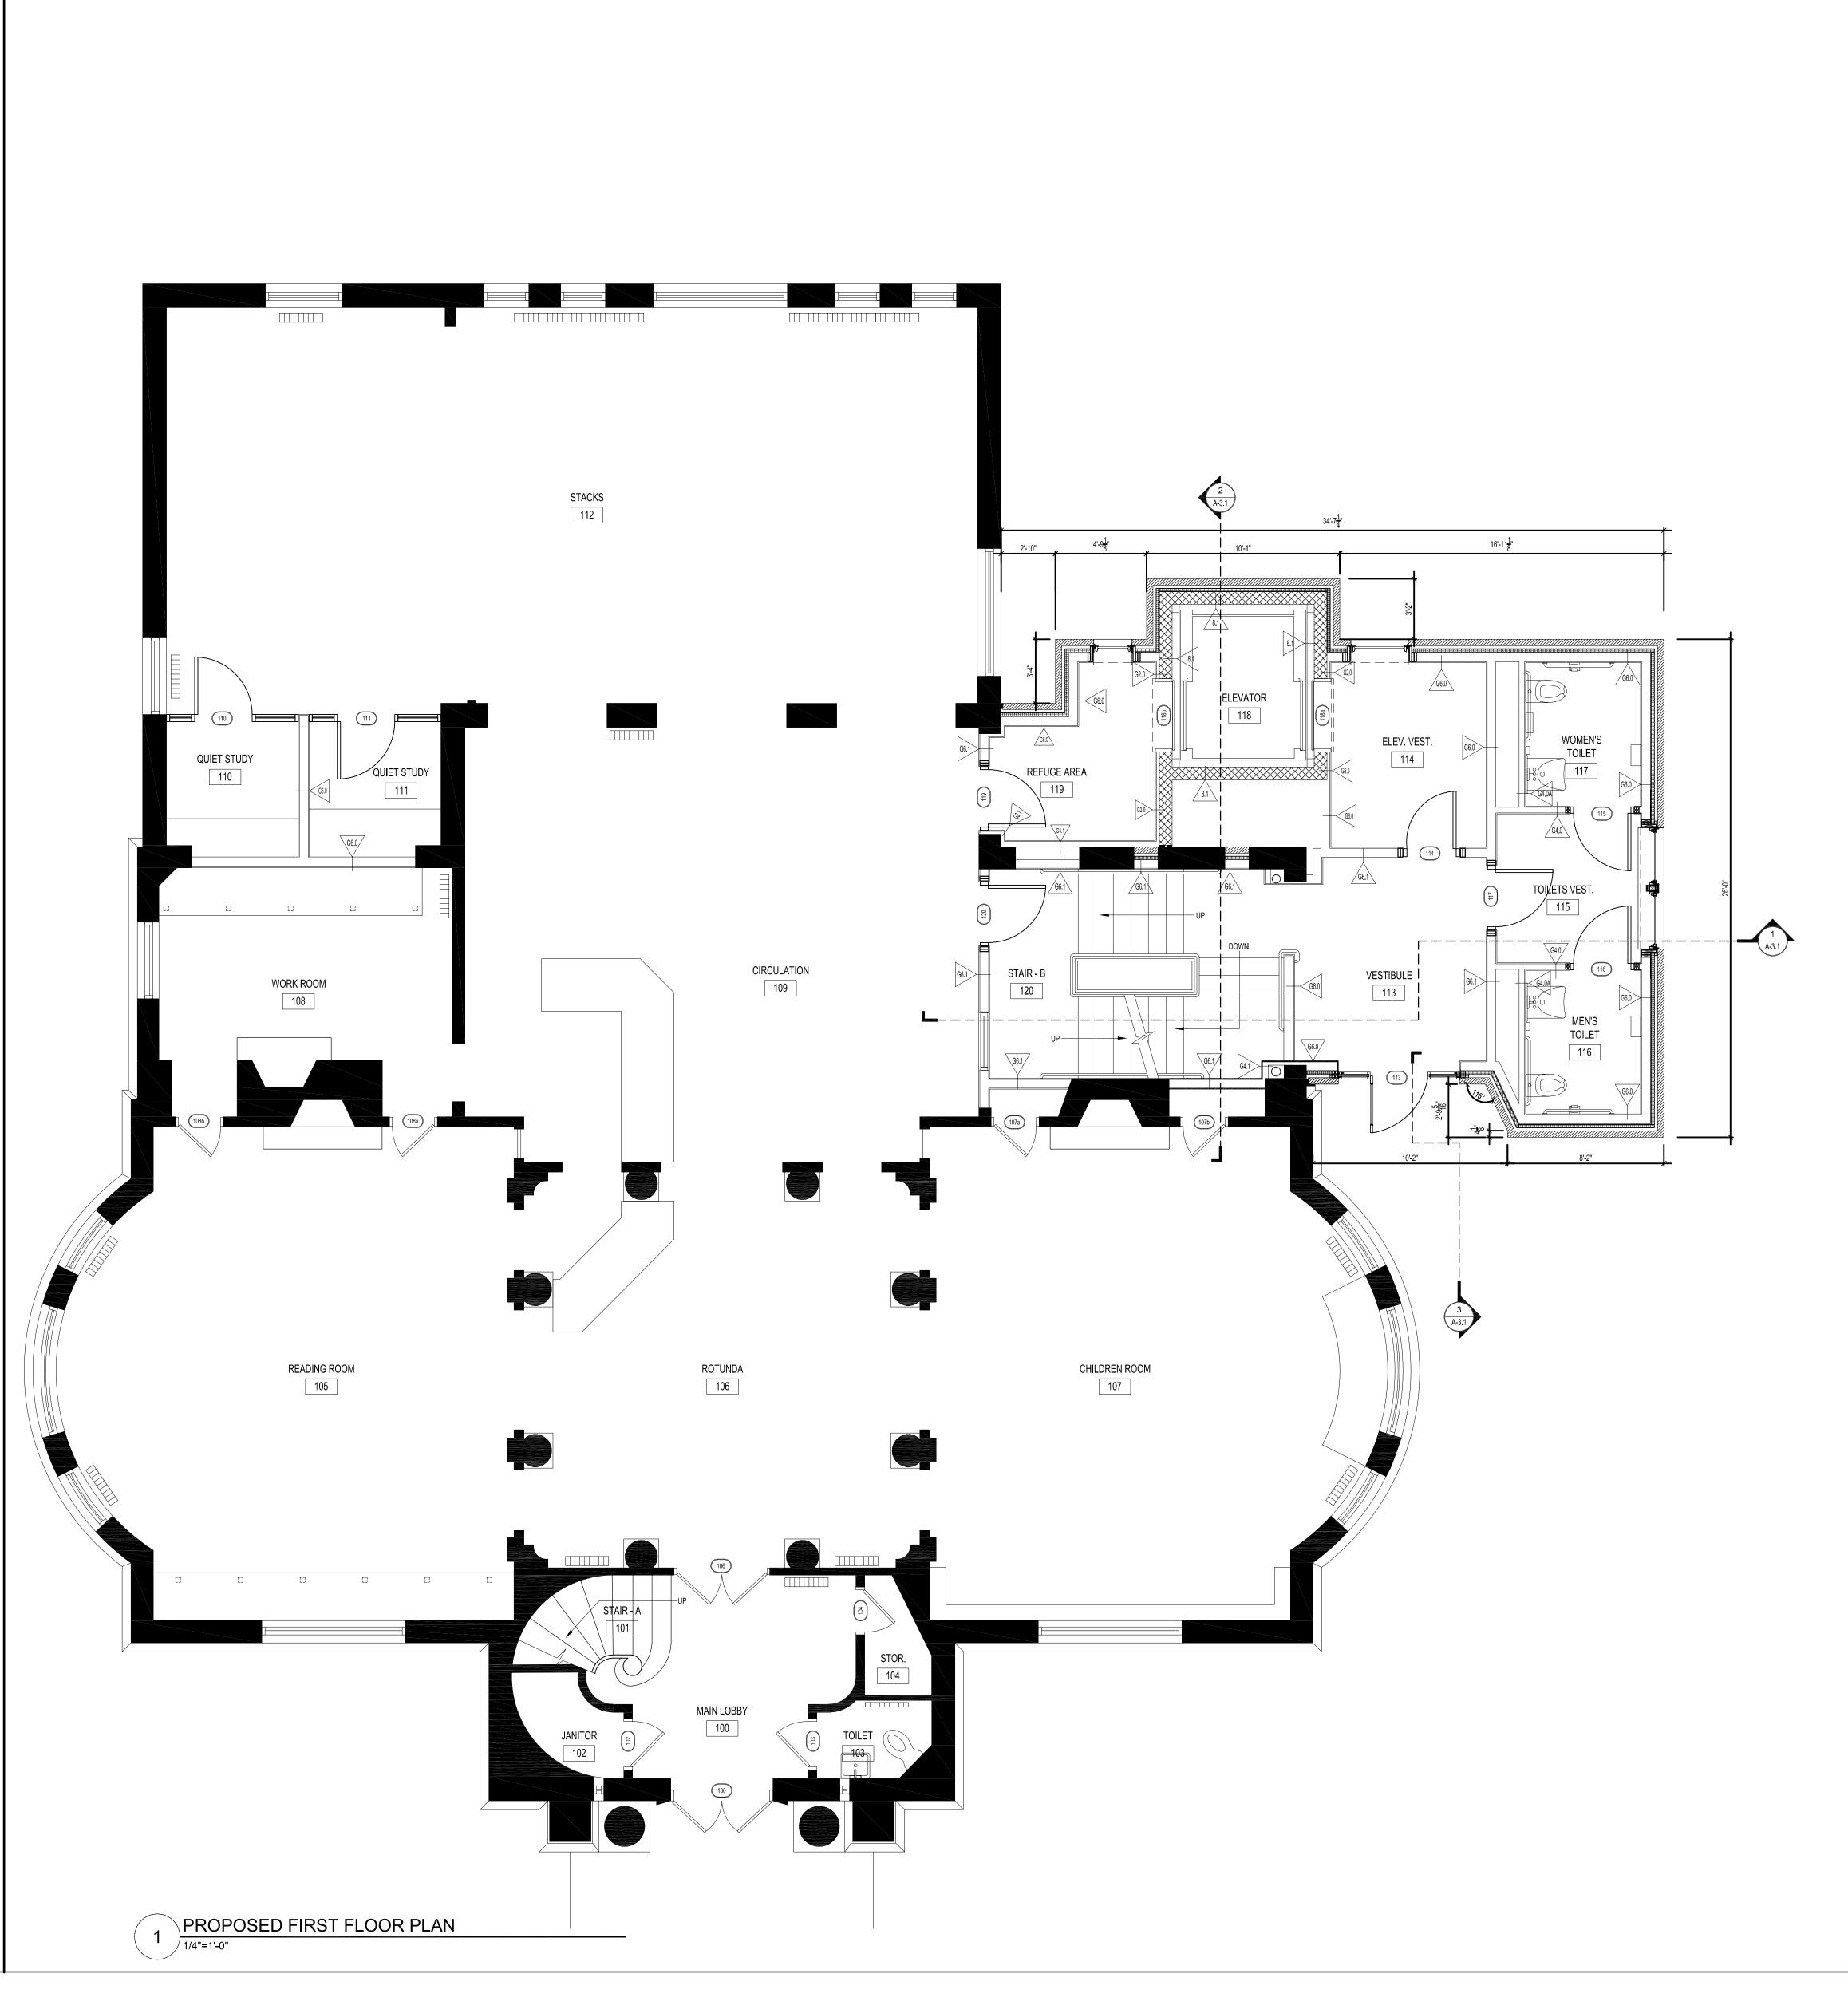



225 OAKLAND ROAD SOUTH WINDSOR,CT

phone: 860-644-8300 fax: 860-644-8301 Architecture info@draws.com

GREAT BARRINGTON -RAMSDELL **LIBRARY**


GREAT BARRINGTON, MASSACHUSETTS

PROGRESS PRINT May 25.10

NOT FOR CONSTRUCTION

FOR REVIEW 11-17-23

KEY PLAN

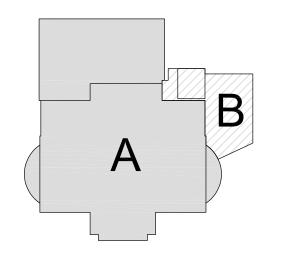




FIRST FLOOR PLANS

cale: **AS NOTED** Orawn by: **DRA**

ate: **May 25, 2010**

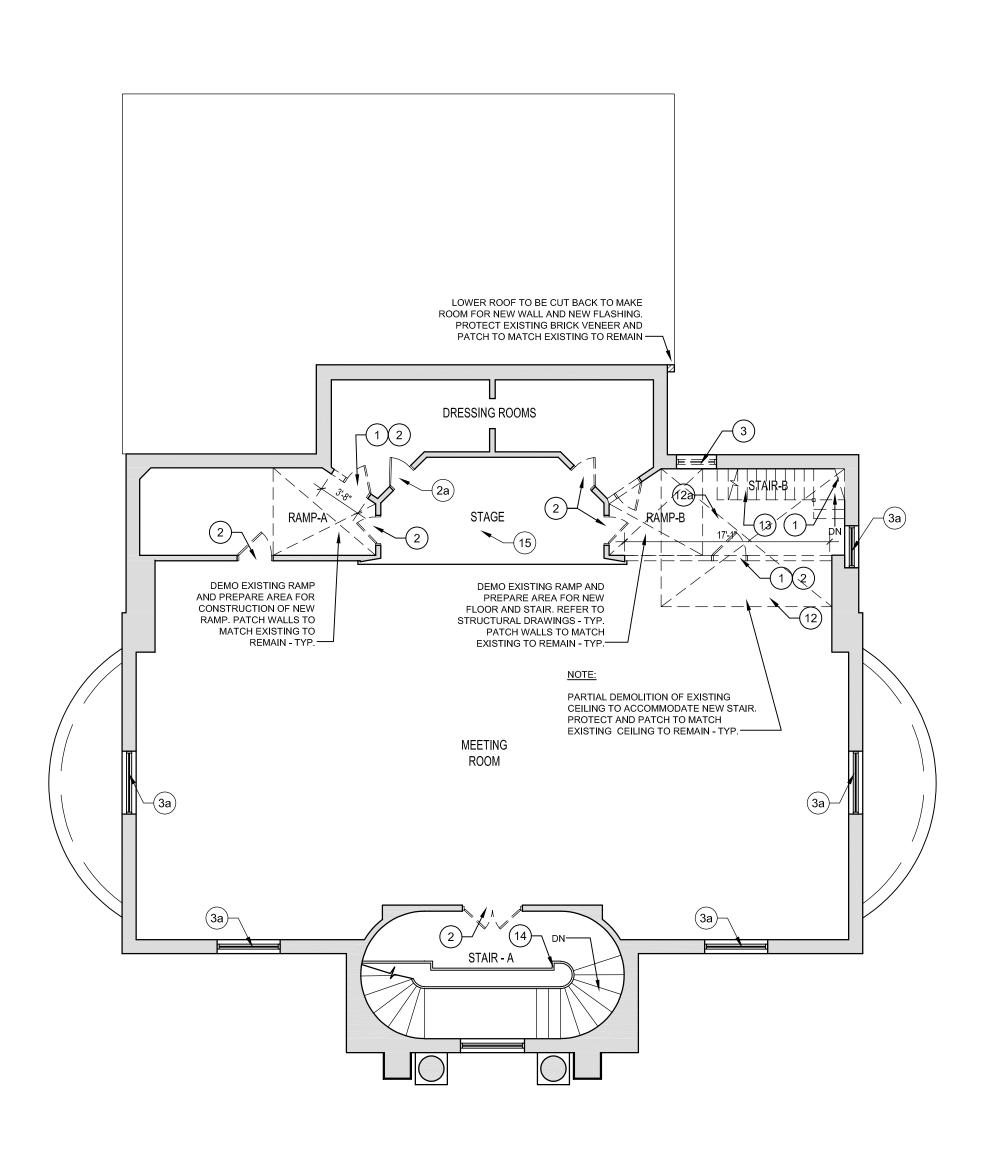

3 DEMOLITION FIRST FLOOR PLAN 1/8"=1'-0"

LEGEND DEMO NOTES:

1. REMOVE EXISTING WOOD OR METAL PARTITION(S). PATCH FLOOR, WALLS AND CEILING TO MATCH EXISTING TO REMAIN. PREPARE AREA FOR NEW FINISH.

1a. REMOVE EXTERIOR MASONRY WALL AND ASSOCIATED ELEMENTS.
PATCH FLOOR AND WALLS TO MACH EXISTING TO REMAIN. ALLOW
MASONRY UNITS TO BE EITHER TOOTHED OR SAW CUT AS REQUIRED
FOR NEW WORK. PREPARE AREA FOR NEW FINISH.

 REMOVE DOOR(S), FRAMES, INCLUDING TRANSOM PANEL(S), BLOCKING TRIM AND THRESHOLD WHERE EXISTING. EXPOSED ROUGH OPENING. PREPARE AREA FOR NEW FINISH.
 PROTECT EXISTING DOOR, HARDWARE AND ALL ASSOCIATED

ELEMENTS TO REMAIN DURING DEMOLITION AND CONSTRUCTION PHASES.

3. REMOVE EXISTING WINDOW UNIT(S) WITH FRAMES, ASSOCIATED

WOOD BLOCKING, AND WINDOW TREATMENTS WHERE EXISTING AS REQUIRED FOR NEW FINISH.

REMAIN DURING DEMOLITION AND CONSTRUCTION PHASES.

3a. PROTECT EXISTING WINDOW(S) AND ALL ASSOCIATED ELEMENTS TO

4. PROTECT EXISTING RADIATOR(S) TO REMAIN DURING DEMOLITION AND CONSTRUCTION PHASES.

5. REMOVE EXISTING PLUMBING FIXTURES AND LINES BACK TO A POINT WHICH WOULD NOT INTERFERE WITH NEW WORK. CAP PLUMBING LINES. REFER TO PLUMBING DRAWINGS FOR ADDITIONAL INFORMATION.

5a. PROTECT PLUMBING FIXTURES AND TOILET ACCESSORIES TO REMAIN.

6. PROTECT EXISTING RAIN LEADER. REFER TO PLUMBING DRAWINGS FOR ADDITIONAL INFORMATION.

7. PROTECT EXISTING SEWER(S) PIPE. REFER TO PLUMBING DRAWINGS FOR ADDITIONAL INFORMATION.

8. REMOVE EXISTING CASEWORK, BUILT-IN SHELVING, TACKBOARDS, COUNTERTOP.

8a. REMOVE AND PROTECT EXISTING RECEPTION DESK. TURN OVER TO THE OWNER.

9. PROTECT EXISTING FIREPLACE, WOOD MANTEL AND ALL ASSOCIATED ELEMENTS TO REMAIN DURING DEMO AND CONSTRUCTION PHASES.

10. PROTECT EXISTING MARBLE COLUMN(S), ALL ASSOCIATED ELEMENTS AND WOOD TRIMS TO REMAIN DURING DEMO AND CONSTRUCTION PHASES.

11. REMOVE WALL COVERINGS FROM EXISTING MARBLE COLUMN(S)
AND ALL ASSOCIATED ELEMENTS. RE-FINISH TO MATCH EXISTING.
PROTECT COLUMN(S) AND WOOD TRIMS TO REMAIN DURING DEMO AND
CONSTRUCTION PHASES.

12. REMOVE AND SALVAGE WOOD FLOOR TO BE RE-INSTALL WHERE PARTITION WALLS WERE REMOVED. REFER TO STRUCTURAL DRAWINGS FOR COORDINATION OF NEW STAIR.

12a. REMOVE ALL EXISTING FINISH CEILING MATERIAL, LIGHT FIXTURES AND DUCTWORK WHERE EXISTING. REFER TO 'MEP' DRAWINGS.


13. REMOVE EXISTING WOODEN STAIR, PILASTERS, HANDRAILS AND BASE. PREPARE AREA FOR NEW WORK. REFER TO STRUCTURAL DRAWINGS

14. PROTECT EXISTING WOODEN STAIR, PILASTERS, HANDRAILS AND BASE TO REMAIN. NO CONTRACTOR ARE ALLOW TO USE STAIR DURING DEMO AND CONSTRUCTION PHASES.

15. PROTECT EXISTING STAGE FLOOR DURING DEMO AND CONSTRUCTION PHASES.

16. PROTECT EXISTING COLUMNS TO REMAIN. REFER TO STRUCTURAL DRAWINGS.

17. PROTECT EXISTING ELECTRICAL PANELS AND RELATED COMPONENTS. REFER TO ELECTRICAL DRAWINGS.

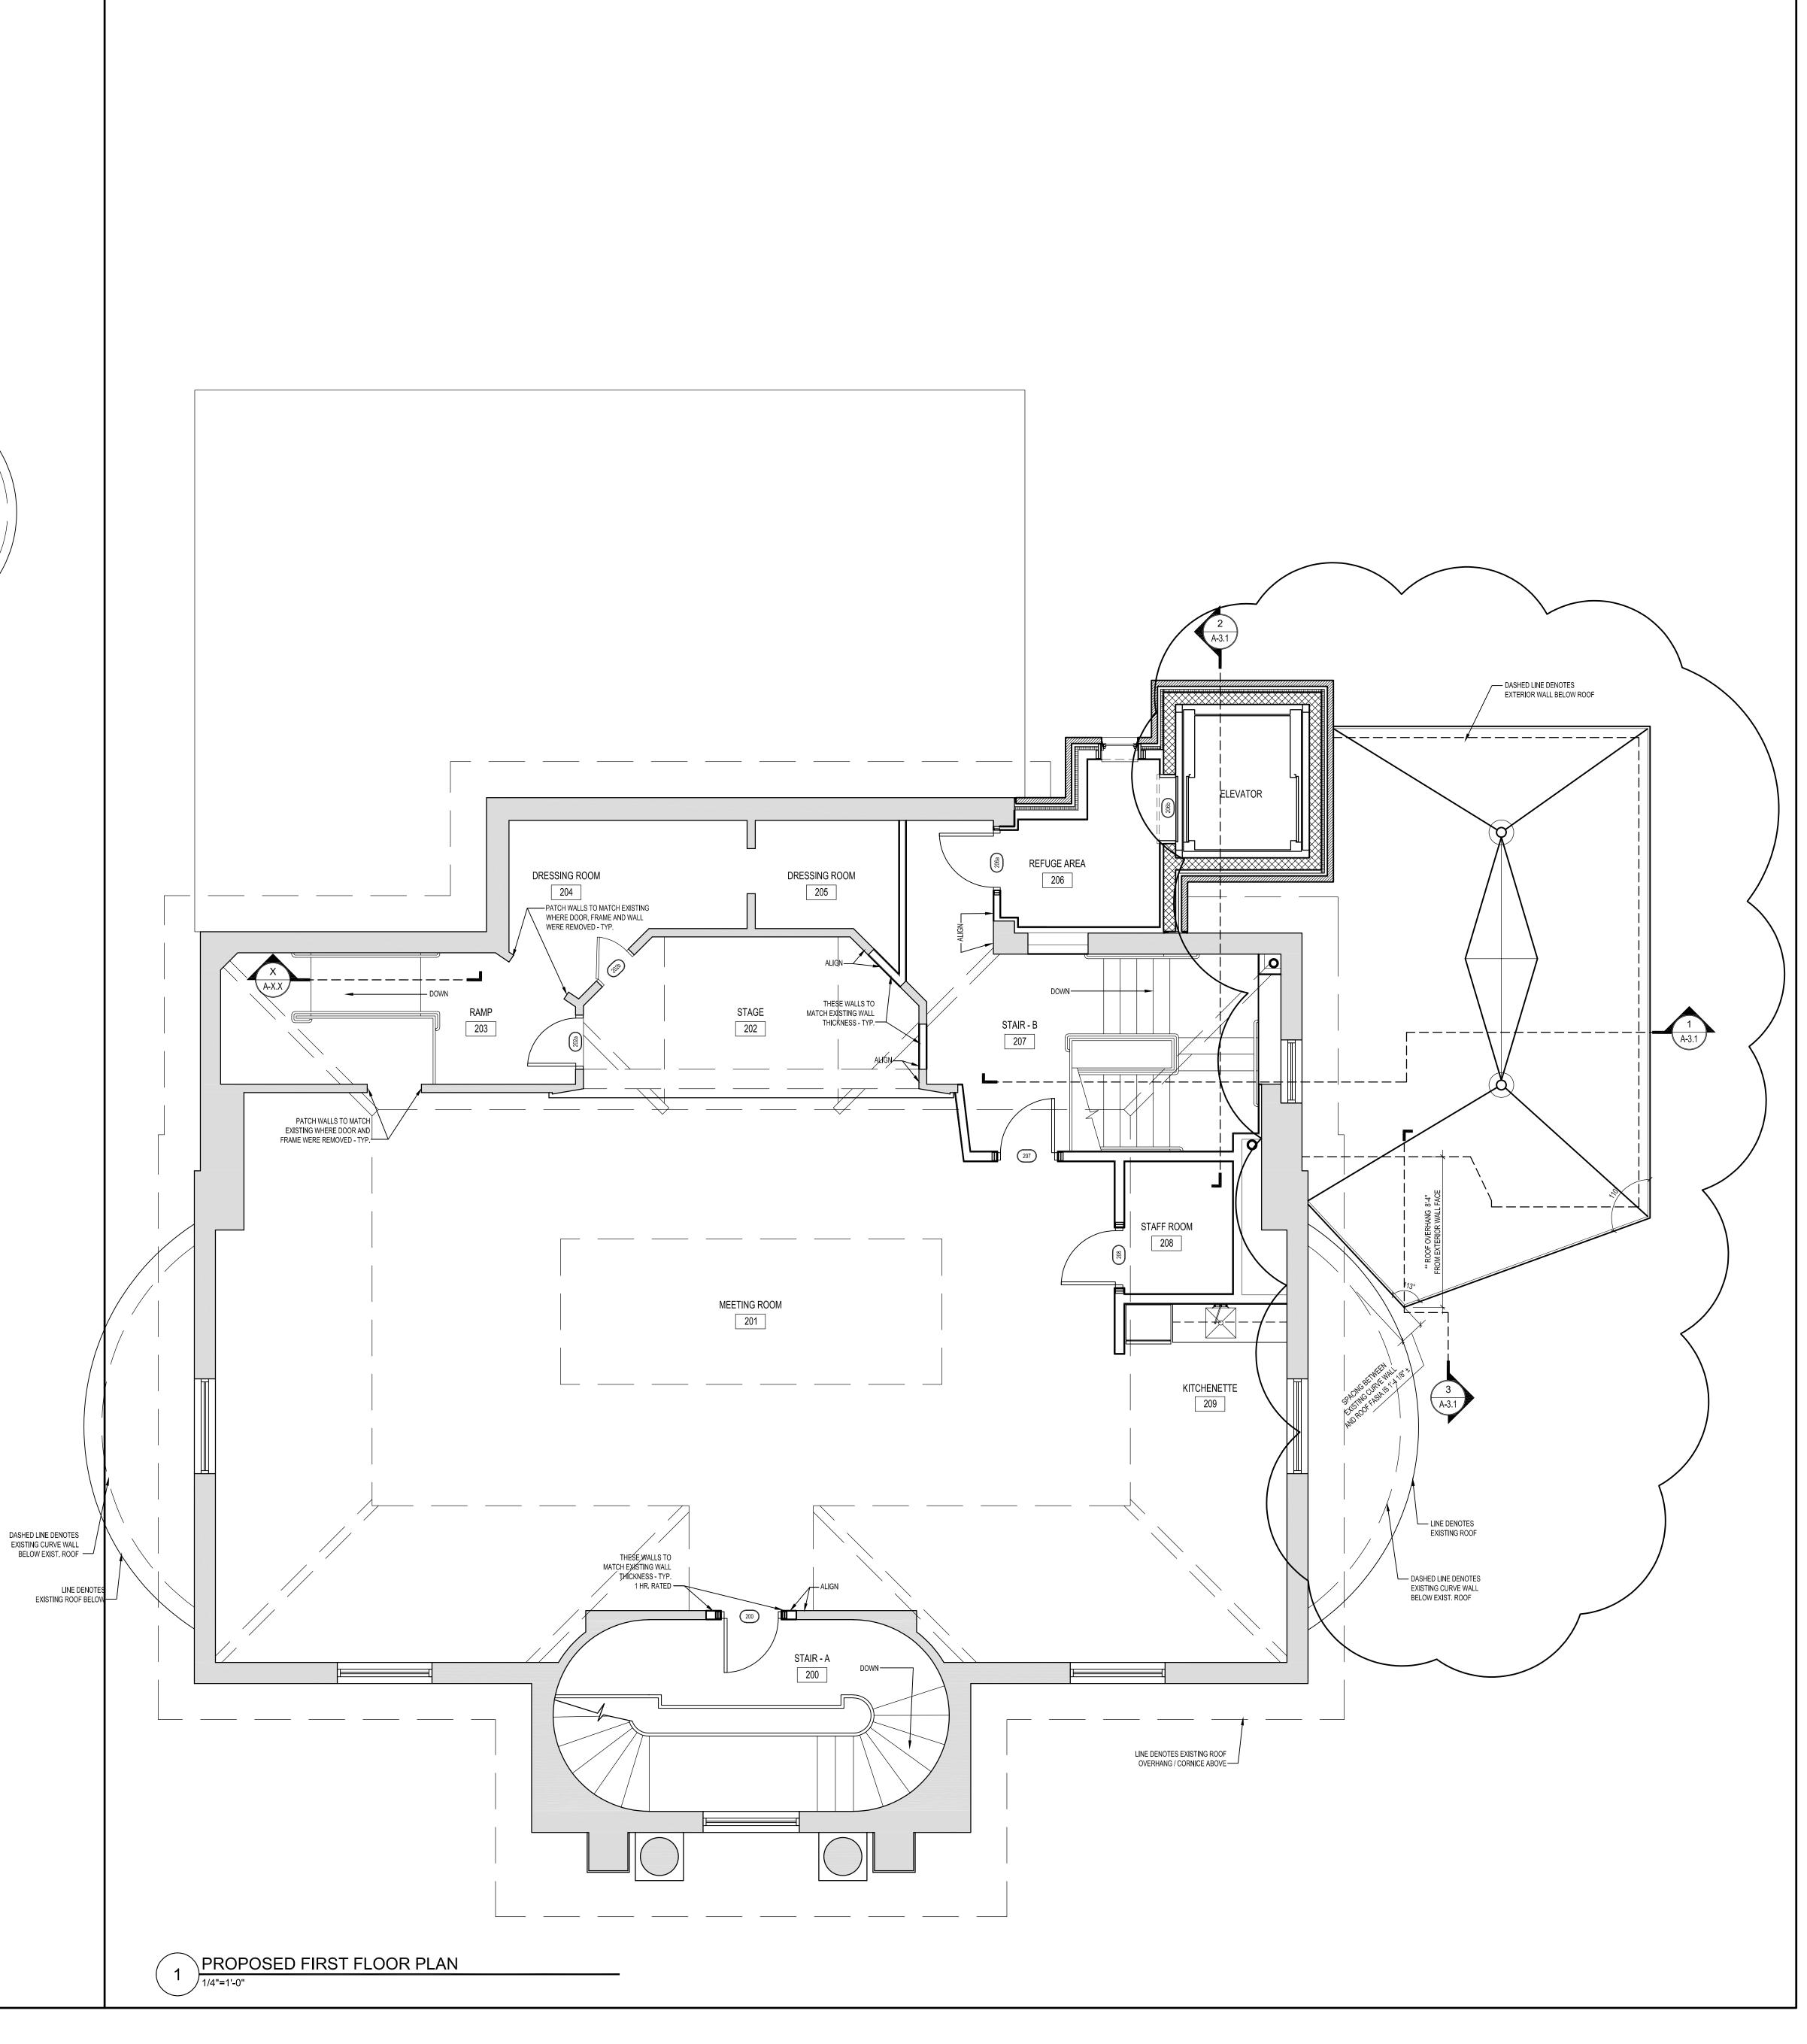



Drummey Rosane Anderson,

STUDIO 205 225 OAKLAND ROAD SOUTH WINDSOR,CT 06074

Planning phone: 860-644-8300
Architecture fax: 860-644-8301
Interior Design info@draws.com

GREAT
BARRINGTON RAMSDELL
LIBRARY


GREAT BARRINGTON, MASSACHUSETTS

PROGRESS PRINT May 25.10

NOT FOR CONSTRUCTION

FOR REVIEW ONLY 11-17-23

KEY PLAN

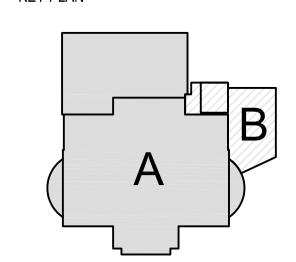




SECOND FLOOR PLANS

Scale: AS NOTED
Job No.: 09013.00
Drawn by: DRA

Date: May 25, 2010

A-1.3

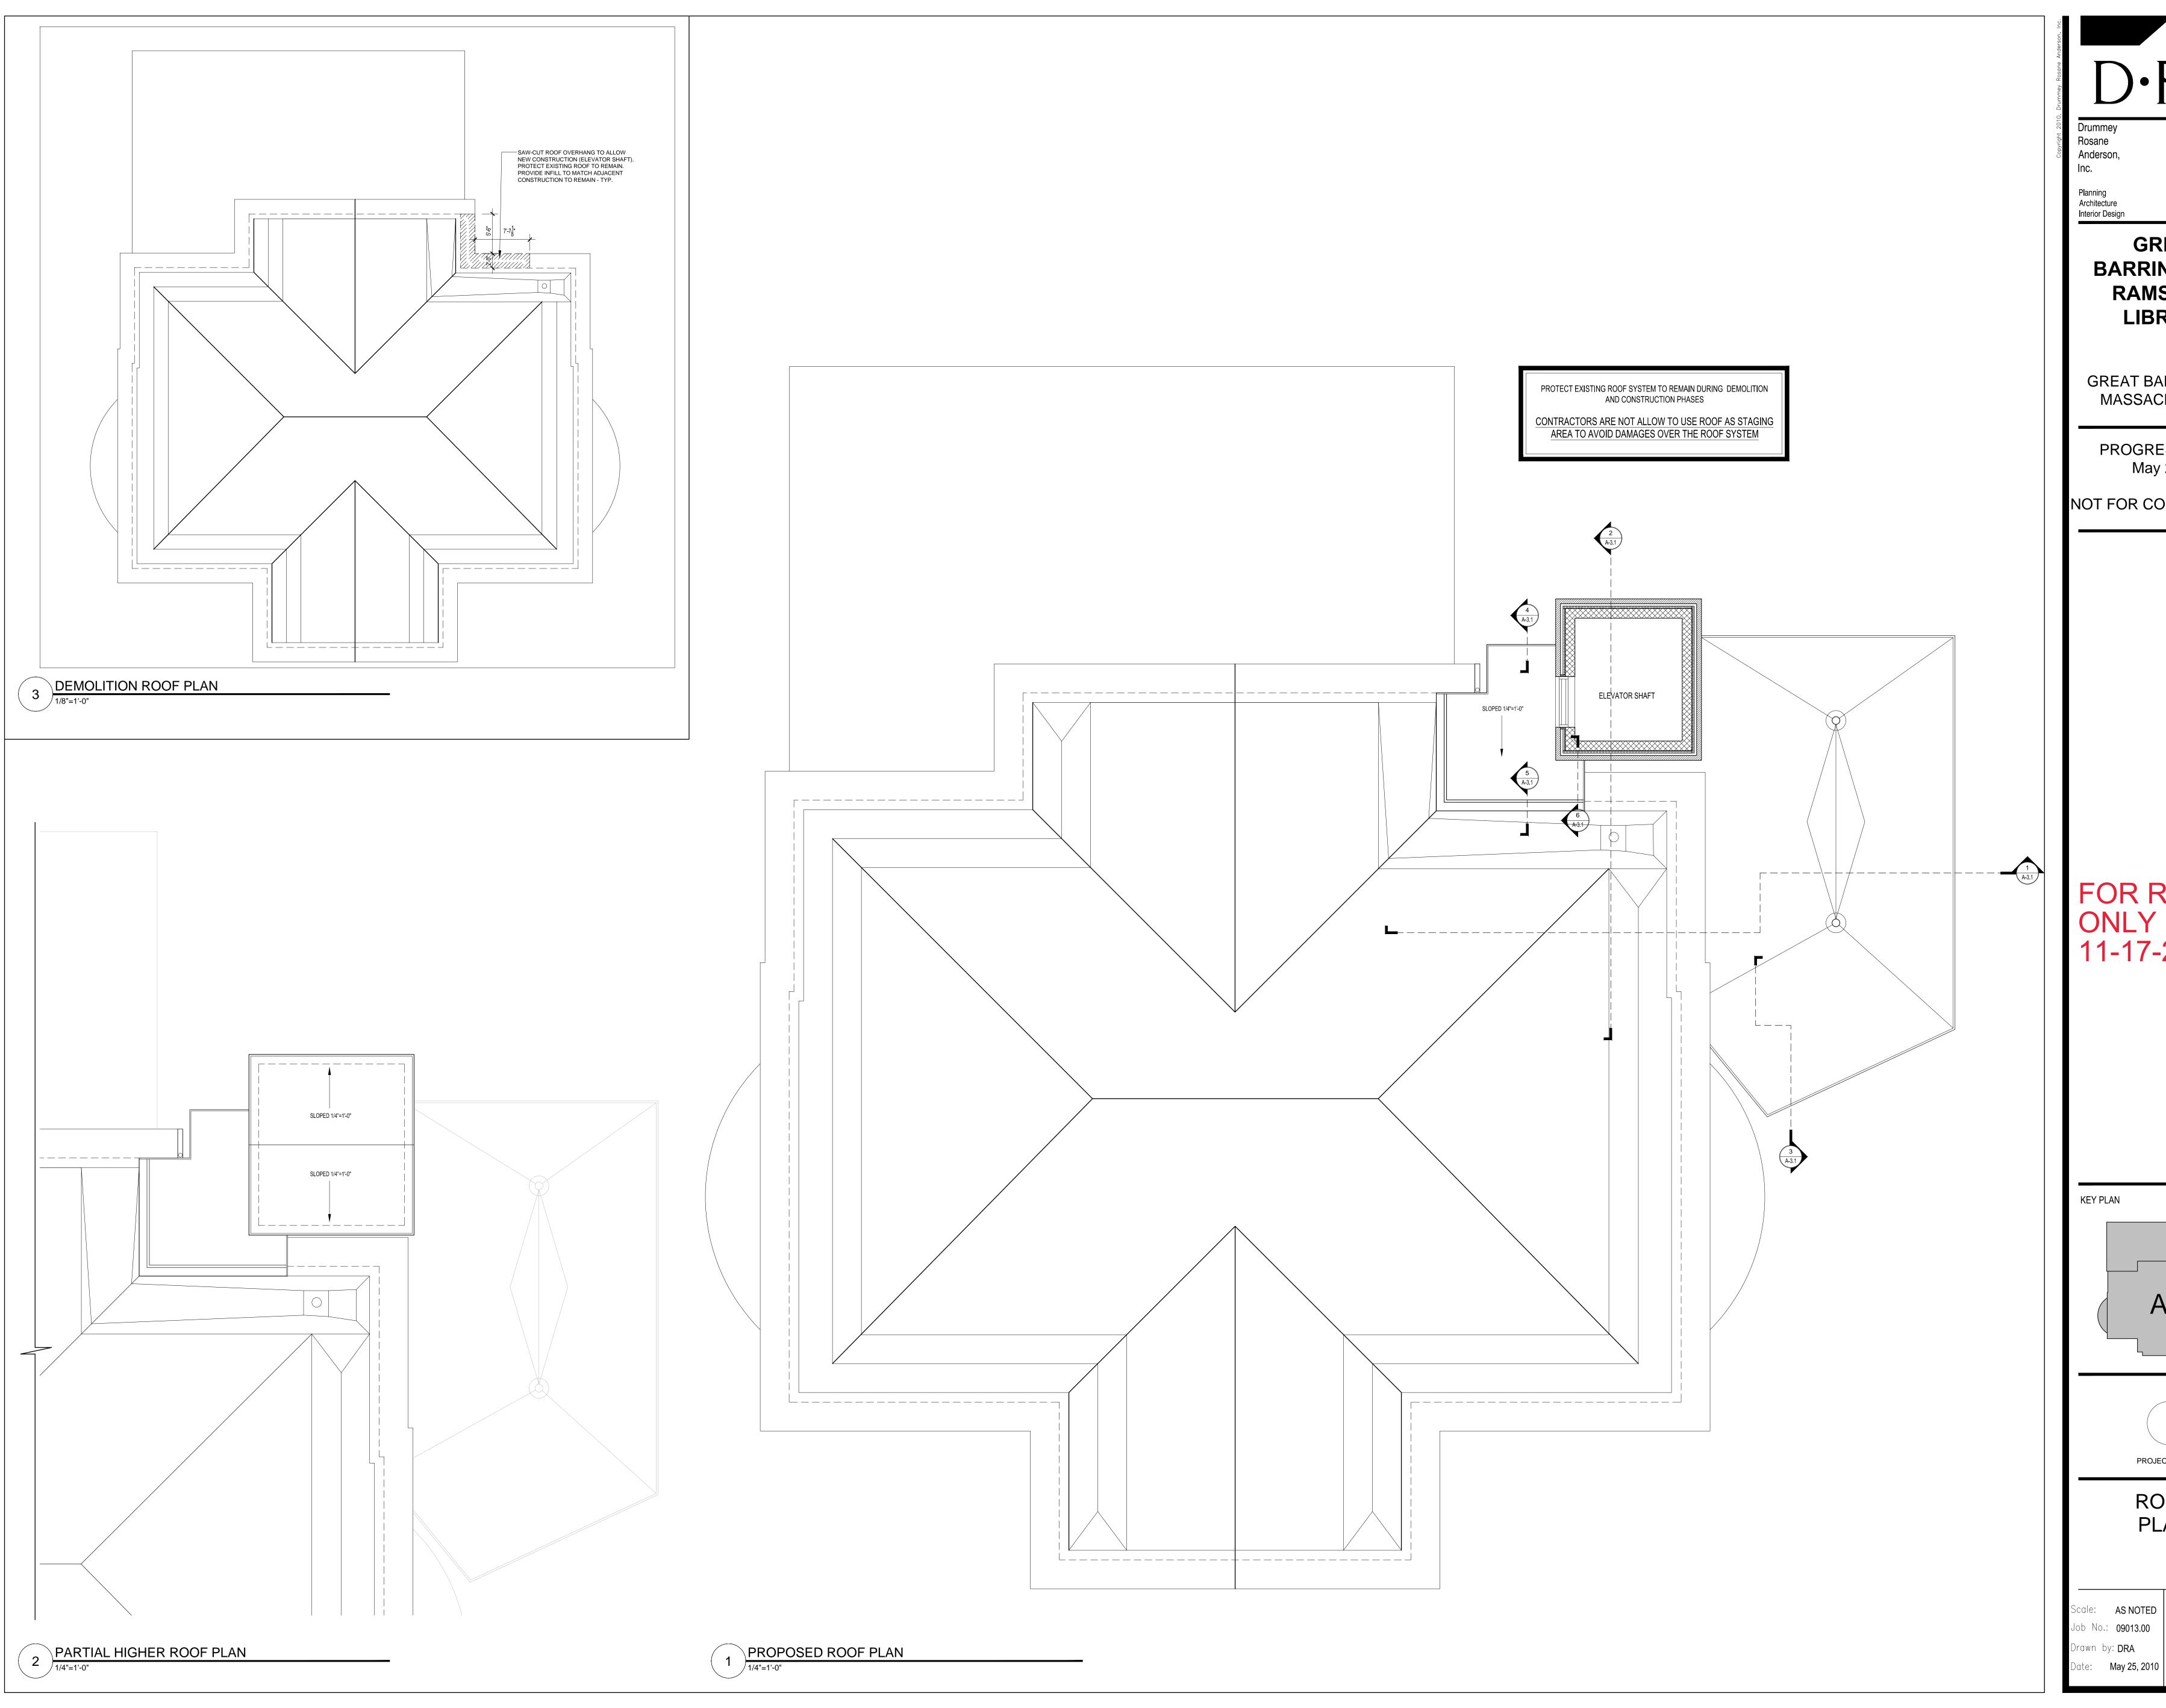



STUDIO 205

225 OAKLAND ROAD

SOUTH WINDSOR,CT


phone: 860-644-8300 fax: 860-644-8301 info@draws.com

GREAT BARRINGTON -RAMSDELL LIBRARY

GREAT BARRINGTON, MASSACHUSETTS

PROGRESS PRINT May 25.10


NOT FOR CONSTRUCTION

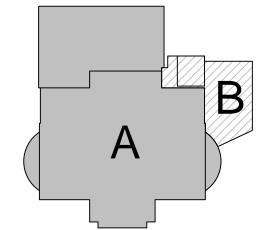



ROOF

PLAN

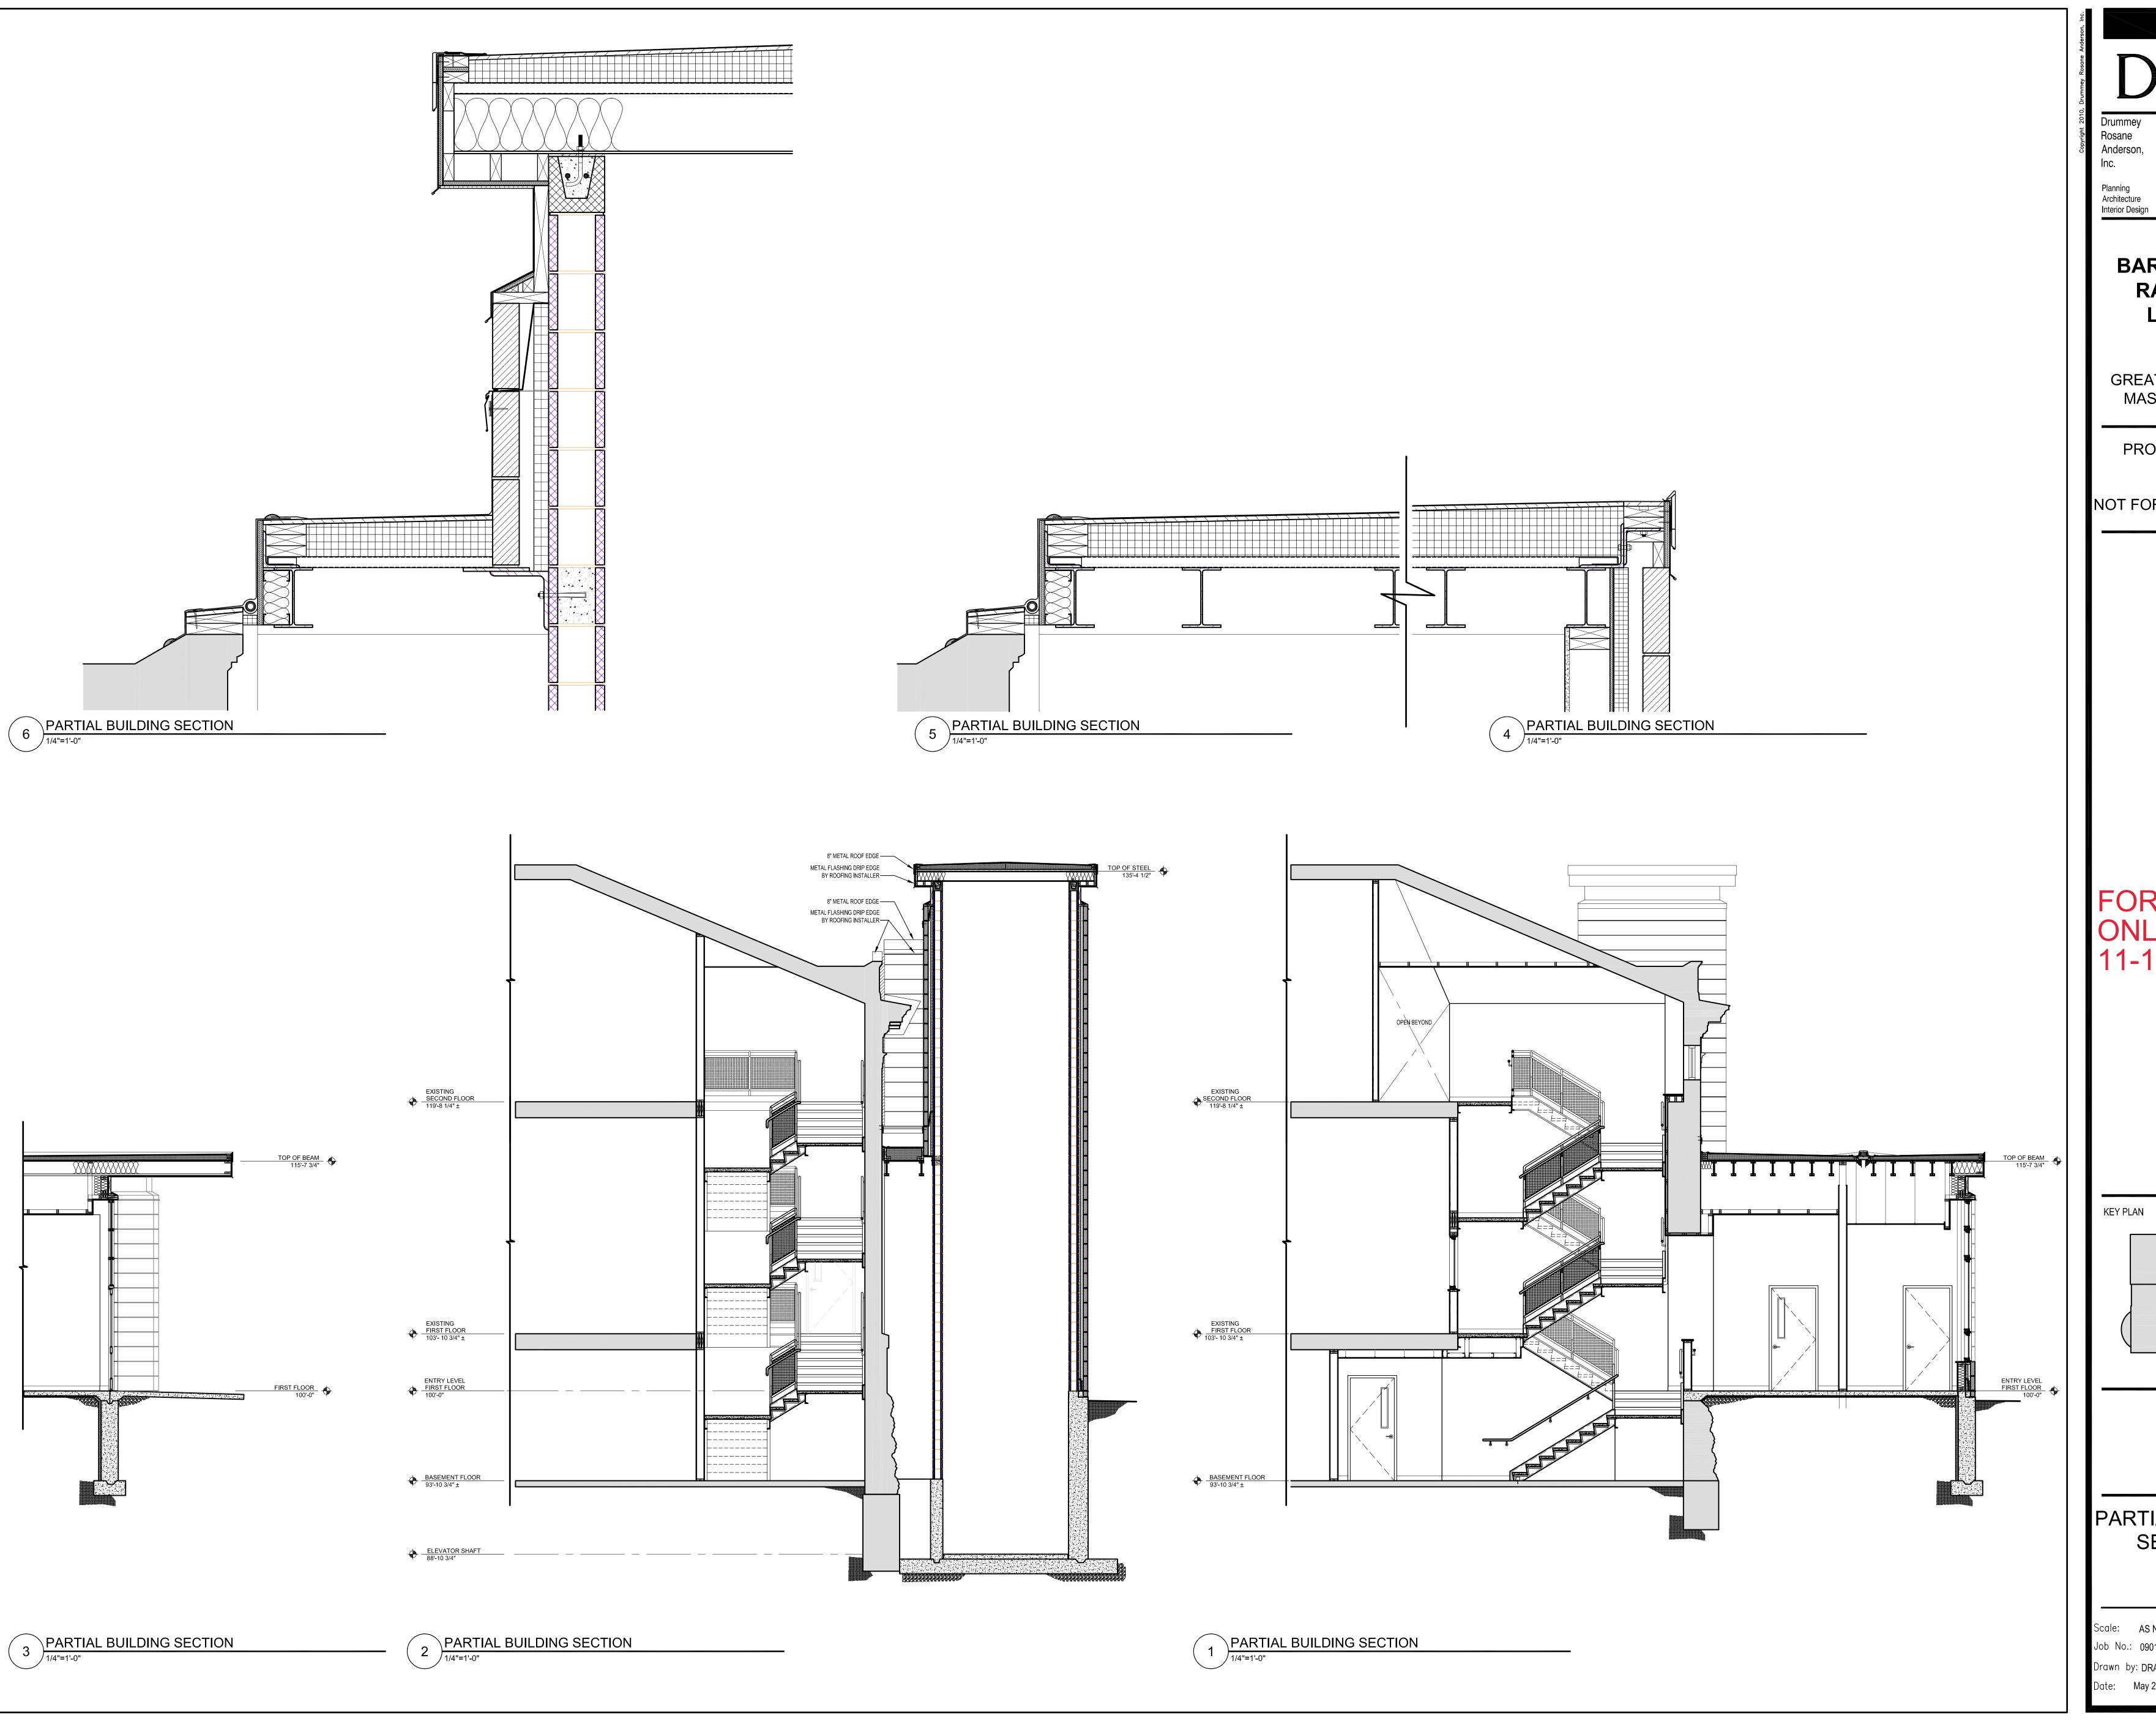



Drummey Rosane Anderson,

STUDIO 205 225 OAKLAND ROAD SOUTH WINDSOR,CT

info@draws.com **GREAT BARRINGTON -**

phone: 860-644-8300 fax: 860-644-8301

GREAT BARRINGTON, MASSACHUSETTS

RAMSDELL


LIBRARY

PROGRESS PRINT May 25.10

NOT FOR CONSTRUCTION

FOR REVIEW ONLY 11-17-23

KEY PLAN

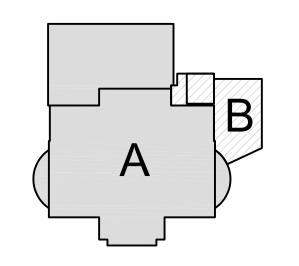



PARTIAL BUILDING SECTIONS

Drawn by: DRA Date: May 25, 2010


| WINDOWS FRAME W REMARKS | | | | | | | | | | | | |
|-------------------------|----------|--------------------|--------------------|---------------|------|-----|------|------|----------------------|-----------------------|------------------|--|
| > ~ | WINDOWS | | | | | | | rK/ | AIVIE | | Å | REMARKS |
| WINDOW | | - | SIZE | _ 낮 | ш | | ш | MAT. | B AIL | HEAD DETAIL sht | HARDWAF GROUP | |
| N N | ROOM NO. | ROOM NAME | WXH | THICK. | TYPE | MAT | TYPE | | JAMB DETAI sht | | HAR | |
| W1 | 109 | CIRCULATION ROOM | 3'-0" X 4'-11 1/8" | | | GL | A | ٩L | | | | 1 HR. RATED - FIXED, VIF - DIMENSION BEFORE PROVIDING UNIT |
| W2 | 117 | TOILETS VESTIBULE | 3"-0" X 6'-8 1/4" | | | GL | A | ٩L | | | | OPERABLE, VIF - DIMENSION BEFORE PROVIDING UNIT |
| W3 | 114 | ELEVATOR VESTIBULE | 3'-0" X 8'-11 3/8" | | | GL | A | ٩L | | | | OPERABLE, VIF - DIMENSION BEFORE PROVIDING UNIT |
| W3 | 119 | REFUGE AREA | 3'-0" X 8'-11 3/8" | | | GL | A | ٩L | | | | OPERABLE, VIF - DIMENSION BEFORE PROVIDING UNIT |
| W4 | 206 | REFUGE AREA | 3'-0" X 4'-6 1/4" | | | GL | A | ٩L | | | | OPERABLE, VIF - DIMENSION BEFORE PROVIDING UNIT |
| W4 | 117 | TOILETS VESTIBULE | 3'-0" X 4'-6 1/4" | | | GL | A | ٩L | | | | OPERABLE, VIF - DIMENSION BEFORE PROVIDING UNIT |
| W5 | 206 | REFUGE AREA | 3'-0" X 4'-6 1/4" | | | GL | A | ٩L | | | | OPERABLE, VIF - DIMENSION BEFORE PROVIDING UNIT |


| ~ | DOORS | | | | | | | F | FRAME | | (HRS) | SAD | DLE | RE | REMARKS |
|----------------|----------|--------------------|---------------|---------------------------------|------|----------|--------|----------|-----------------------|-----------------------|-------------------|--------|-----|-------------------|--------------------------------|
| DOOR NUMBER | | | SIZE | THICK. | JC . | <u>.</u> | | <u> </u> | JAMB DETAIL sht | HEAD DETAIL sht | FIRE RATING (H | DETAIL | L. | HARDWARE GROUP | |
| □ N | ROOM NO. | ROOM NAME | WxH | 돈 | TYPE | MAT | N V | MAT | JAN DE: | SH CH. | FIR RA | DE. | MAT | HA | |
| B01 | B01 | STAIR - B | 3'-0" X 7'-0" | 13" | С | MTL | | MTL | | | 1 | | | | VISION PANEL IN DOOR, PAINTED |
| B02 | B02 | ELEV. MACHINE ROOM | 3'-0" X 7'-0" | 13" | В | MTL | | MTL | | | 1 | | | | PAINTED |
| B03a | B03 | REFUGE AREA | 3'-0" X 7'-0" | 13" | С | MTL | | MTL | | | 1 | | | | VISION PANEL IN DOOR, PAINTED |
| B03b | B03 | REFUGE AREA | 3'-0" X 7'-0" | 13" | С | MTL | | MTL | | | 1 | | | | VISION PANEL IN DOOR, PAINTED |
| B03c | B03 | REFUGE AREA | 3'-6" X 7'-0" | 13" | Е | AL | | MTL | | | - | | | | ELEVATOR DOOR |
| B05 | B05 | BASEMENT | 3'-0" X 7'-0" | 13" | F | MTL | | MTL | | | 1 | | | | PAINTED |
| B06 | B06 | STORAGE | EXISTING | EX | D | EX | | EX | | | - | | | | |
| | | | | | | | | | | | | | | | |
| 100 | 100 | MAIN LOBBY | EXISTING | EX | | EX | | EX | | | - | | | | - |
| 102 | 102 | JANITOR | EXISTING | EX | D | EX | | EX | | | - | | | | - |
| 103 | 103 | TOILET | EXISTING | EX | D | EX | | EX | | | - | | | | - |
| 104 | 104 | STORAGE | EXISTING | EX | D | EX | | EX | | | - | | | | - |
| 106 | 106 | ROTUNDA | EXISTING | EX | D | EX | | EX | | | - | | | | - |
| 107a | 107 | CHILDREN ROOM | EXISTING | EX | D | EX | | EX | | | - | | | | - |
| 107b | 107 | CHILDREN ROOM | EXISTING | EX | D | EX | | EX | | | - | | | | - |
| 108a | 108 | WORK ROOM | EXISTING | EX | D | EX | | EX | | | - | | | | - |
| 108b | 108 | WORK ROOM | EXISTING | EX | D | EX | | EX | | | - | | | | - |
| 110 | 110 | QUIET STUDY | 3'-0" X 7'-0" | 1 ³ " | В | WD | | MTL | | | - | | | | - |
| 111 | 111 | QUIET STUDY | 3'-0" X 7'-0" | 1 ³ " | В | WD | | MTL | | | - | | | | - |
| 113 | 113 | VESTIBULE | 3'-0" X 7'-0" | 13" | Α | AL | | AL | | | - | | | | STOREFRONT SYSTEM, SEE TYPE |
| 114 | 114 | ELEV. VESTIBULE | 3'-0" X 7'-0" | 13" | С | MTL | | MTL | | | 1 | | | | VISION PANEL IN DOOR, PAINTED |
| 115 | 115 | WOMEN'S TOILET | 3'-0" X 7'-0" | 1 ³ " | В | MTL | | MTL | | | - | | | | - |
| 116 | 116 | MEN'S TOILET | 3'-0" X 7'-0" | 13" | В | MTL | | MTL | | | - | | | | - |
| 117 | 117 | TOILET'S VESTIBULE | 3'-0" X 7'-0" | 13" | С | MTL | | MTL | | | 1 | | | | |
| 118a | 118 | ELEVATOR | 3'-6" X 7'-0" | 13" | | AL | | MTL | | | - | | | | - |
| 118b | 118 | ELEVATOR | 3'-6" X 7'-0" | 1 ³ " | | AL | | MTL | | | - | | | | - |
| 119 | 119 | REFUGE AREA | 3'-0" X 7'-0" | 1 ³ ₄ " | С | MTL | | MTL | | | 1 | | | | VISION PANEL IN DOOR, PAINTED |
| 120 | 120 | STAIR - B | 3'-0" X 7'-0" | 13" | С | MTL | | MTL | | | 1 | | | | VISION PANEL IN DOOR, PAINTED |
| 200 | 200 | STAIR - A | 3'-0" X 7'-0" | 1 ³ / ₄ " | | WD | | MTL | | | 1 | | | | VISION PANEL IN DOOR |
| 200 202a | 200 | STAGE | 2'-8" X 7'-0" | 13" | | WD | | MTL | | | - | | | | VISION FAINEL IN DOOR |
| 202a 202b | 202 | STAGE | EXISTING | EX | | EX | | EX | | | + - | | | | - |
| | 202 | REFUGE AREA | 3'-0" X 7'-0" | 1 ³ " | | MTL | | MTL | | | 1 | | | | VISION PANEL IN DOOR, PAINTED |
| 206a 207 | 206 | STAIR - B | 3'-0" X 7'-0" | | | MTL | | MTL | | | 1 | | | | VISION FAINEL IN DOOK, PAINTED |
| | | STAFF ROOM | 3'-0" X 7'-0" | 13" | | MTL | | MTL | | | 1 | | | | - |
| 208 | 208 | STAFF NOUN | 3-U A / -U | 13" | D | IVIIL | | IVIIL | | _ | - | | | | - |

| DOO | R & WINDOW SCHEDULE LEGEND |
|-----|------------------------------|
| GL | ALUMINUM DOORS GLASS INSERTS |
| AL | ALUMINUM |
| MTL | METAL |
| EX | EXISTING |


| - K | ROOM NAME | FLOO | R | BASE | | | W | ALLS | | CEILI | NGS | REMARKS |
|----------------|--------------------|------|--------|-------|------|----------------------|----------------|-----------------|----------------|-----------|------|---|
| ROOM NUMBER | | MAT | | MAT. | 1 | ORTH NISH | EAST FINISH | SOUTH FINISH | WEST FINISH | MAT. HGT. | | |
| B01 | STAIR - B | CPT | _ | RS - | | PT | PT | PT | PT | ACT | - | CARPET FLOORING AT STAIR RISER, TREADS AND LANDINGS |
| B02 | ELEV. MACHINE ROOM | SC | ١. | RS - | | PT | PT | PT | PT | EXP-STR | _ | 4" RESILIENT RUBBER BASE. SEE 'RCP' DRAWINGS. |
| B03 | REFUGE AREA | RT | | RS - | | РТ | PT | PT | PT | ACT | _ | SEE 'RCP' DRAWINGS FOR CEILING HEIGHT |
| B04 | CRAWL SPACE | ETR | _ | | | ETR | ETR | ETR | ETR | EXT | - | |
| B05 | BASEMENT | ETR | | ETR - | | ETR | ETR | ETR | ETR | ETR | EX-H | |
| B06 | STORAGE | ETR | 1 | ETR - | | ETR | ETR | ETR | ETR | ETR | EX-H | _ |
| 100 | MAIN LOBBY | ETR | | ETR - | | ETR | ETR | ETR | ETR | ETR | EX-H | PROTECT EXISTING TERRAZZO / MOSAIC DURING |
| 101 | STAIR - A | ETR | - | ETR - | | ETR | ETR | ETR | ETR | ETR | EX-H | DEMO AND CONSTRUCTION PHASES PROTECT EXISTING FINISHES. NO CONTRACTOR ALLOW TO USE TO |
| 102 | JANITOR | ETR | - | ETR - | | ETR | ETR | ETR | ETR | ETR | EX-H | AREA DURING DEMO AND CONSTRUCTION PHASES PROTECT EXISTING TERRAZZO / MOSAIC DURING |
| 103 | TOILET | ETR | | ETR - | | ETR | ETR | ETR | ETR | ETR | EX-H | DEMO AND CONSTRUCTION PHASES PROTECT EXISTING TERRAZZO / MOSAIC DURING |
| 104 | STORAGE | ETR | - | ETR - | | ETR | ETR | ETR | ETR | ETR | EX-H | DEMO AND CONSTRUCTION PHASES PROTECT EXISTING TERRAZZO / MOSAIC DURING |
| 105 | READING AREA | ETR | - | ETR - | | | ETR | | ETR | ETR | EX-H | DEMO AND CONSTRUCTION PHASES |
| 106 | ROTUNDA | ETR | - | | | ETR | | PT | | | EX-H | - |
| 107 | CHILDREN ROOM | | - | ETR - | | ETR | ETR | ETR | ETR | ETR | | PROTECT EXISTING WOOD FLOOR TO REMAIN DURING DEMO AND |
| 107 | WORK ROOM | ETR | - | ETR - | | ETR | ETR | ETR | ETR | ETR | EX-H | CONSTRUCTION PHASES PROTECT EXISTING WOOD FLOOR TO REMAIN DURING DEMO AND |
| | CIRCULATION | ETR | - | ETR - | | PT D . | ETR | ETR | ETR | ETR | EX-H | CONSTRUCTION PHASES PROTECT EXISTING WOOD FLOOR TO REMAIN DURING DEMO AND |
| 109 | | ETR | - | ETR - | | PT | ETR | ETR | PT | ETR | EX-H | CONSTRUCTION PHASES, PROVIDE BASE TO MATCH EXISTING PROTECT EXISTING WOOD FLOOR TO REMAIN DURING DEMO AND |
| 110 | QUIET STUDY | ETR | - | | - | PT | PT | PT | PT | ACT | - | CONSTRUCTION PHASES. SEE 'RCP' DRAWINGS FOR CEILING HEIC PROTECT EXISTING WOOD FLOOR TO REMAIN DURING DEMO AND |
| 111 | QUIET STUDY | ETR | + - | | | PT | PT | PT | PT | ACT | - | CONSTRUCTION PHASES. SEE 'RCP' DRAWINGS FOR CEILING HEIG PROTECT EXISTING WOOD FLOOR TO REMAIN DURING DEMO AND |
| 112 | STACKS | ETR | - | ETR - | | ETR | ETR | ETR | ETR | ETR | EX-H | CONSTRUCTION PHASES |
| 113 | VESTIBULE | CT | - | RS - | | PT | PT | PT | PT | GWB | - | 4" RESILIENT RUBBER BASE. SEE 'RCP' DRAWINGS. |
| 114 | ELEV. VESTIBULE | CT | - | RS - | | PT | PT | PT | PT | ACT | - | 4" RESILIENT RUBBER BASE. SEE 'RCP' DRAWINGS. |
| 115 | WOMEN'S TOILET | CT | - | RS - | СТ | / PT | CT / PT | CT / PT | CT / PT | ACT | - | 4" RESILIENT RUBBER BASE. SEE 'RCP' DRAWINGS. |
| 116 | MEN'S TOILET | CT | - | RS - | СТ | /PT | CT / PT | CT / PT | CT / PT | ACT | - | 4" RESILIENT RUBBER BASE. SEE 'RCP' DRAWINGS. |
| 117 | TOILET'S VESTIBULE | CT | - | RS - | · | PT | PT | PT | PT | ACT | - | 4" RESILIENT RUBBER BASE. SEE 'RCP' DRAWINGS. |
| 118 | ELEVATOR | CPT | - | | | • | - | - | - | - | - | WALL AND CEILING FINISHES BY ELEVATOR MANUFACTURER |
| 119 | REFUGE AREA | CT | - | RS - | | PT | PT | PT | PT | ACT | - | 4" RESILIENT RUBBER BASE. SEE 'RCP' DRAWINGS. |
| 120 | STAIR - B | CPT | - | RS - | ı | PT | PT | PT | PT | GWB | - | CARPET FLOORING AT STAIR RISER, TREADS AND LANDINGS 4" RESILIENT RUBBER BASE. SEE 'RCP' DRAWINGS. |
| 200 | STAIR - A | ETR | - | ETR - | - E | ETR | ETR | ETR | ETR | ETR | EX-H | PROTECT EXISTING FINISHES. NO CONTRACTOR ALLOW TO USE T AREA DURING DEMO AND CONSTRUCTION PHASES |
| 201 | MEETING ROOM | ETR | - | ETR - | i i | ETR | ETR | ETR | PT | ETR | EX-H | 4" RESILIENT RUBBER BASE. |
| 202 | STAGE | ETR | - | ETR - | E | ETR | ETR | ETR | PT | ETR | EX-H | PROVIDE BASE TO MATCH EXISTING |
| 203 | RAMP | ETR | RT /RB | | RS I | PT | PT | PT | PT | ETR | EX-H | RUBBER FLOORING AT RAMP AND RESILIENT TILE AT UPPER LAND 4" RESILIENT RUBBER BASE. |
| 204 | DRESSING ROOM | ETR | - | ETR - | E | ETR | ETR | PT | ETR | ETR | EX-H | PROVIDE BASE TO MATCH EXISTING |
| 205 | DRESSING ROOM | ETR | - | ETR - | | ETR | ETR | PT | PT | ETR | EX-H | PROVIDE BASE TO MATCH EXISTING |
| 206 | REFUGE AREA | RT | - | RS - | ı | PT | PT | PT | PT | ACT | - | SEE 'RCP' DRAWINGS FOR CEILING HEIGHT |
| 207 | STAIR - B | CPT | - | RS - | - | PT | PT | PT | PT | ACT | - | CARPET FLOORING AT STAIR RISER, TREADS AND LANDINGS 4" RESILIENT RUBBER BASE. SEE 'RCP' DRAWINGS. |
| 208 | STAFF ROOM | RT | - | RS - | ı | PT | PT | PT | PT | ACT | - | SEE 'RCP' DRAWINGS FOR CEILING HEIGHT |
| 209 | KITCHENETTE | ETR | - | RS - | | PT | PT | _ | PT | EXT | _ | 4" RESILIENT RUBBER BASE. |

| FINISH SCHEDULE LEGEND | | | | | | | | |
|------------------------|------------------------------------|--|--|--|--|--|--|--|
| RT | RESILIENT TILE FLOORING | | | | | | | |
| RS | RESILIENT BASE | | | | | | | |
| RB | RUBBER FLOORING | | | | | | | |
| SC | SMOOTH CONCRETE FLOORING | | | | | | | |
| CPT | CARPET FLOORING | | | | | | | |
| CT | CERAMIC TILE | | | | | | | |
| PT | PAINT | | | | | | | |
| ACT | ACOUSTIC CEILING TILE AND GRID | | | | | | | |
| AP | ACOUSTICAL PANELS | | | | | | | |
| GWB | GYPSUM BOARD | | | | | | | |
| ETR | EXISTING TO REMAIN | | | | | | | |
| EX-H | EXISTING HEIGHT | | | | | | | |
| EXP STR | EXPOSED STRUCTURE | | | | | | | |
| EX-CEIL. | EXISTING CEILING, NO WORK REQUIRED | | | | | | | |
| • | | | | | | | | |

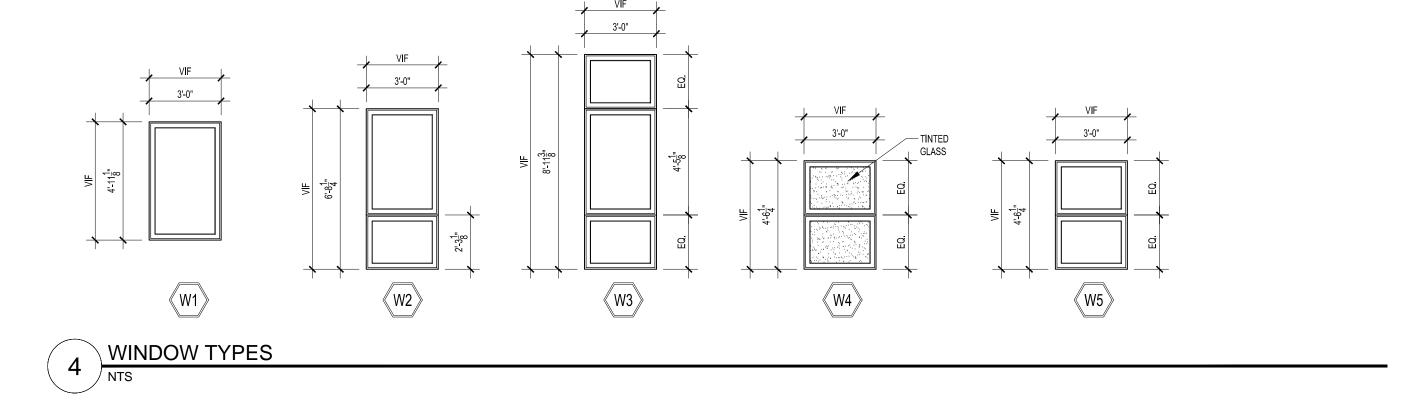


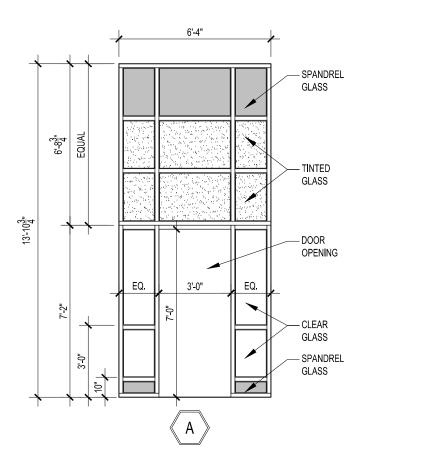

3 STOREFRONT TYPE

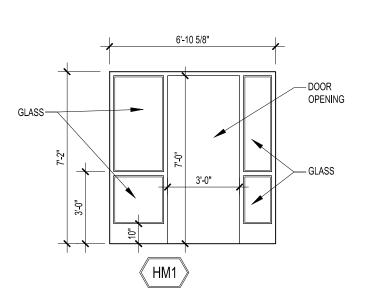

2 HOLLOW METAL TYP

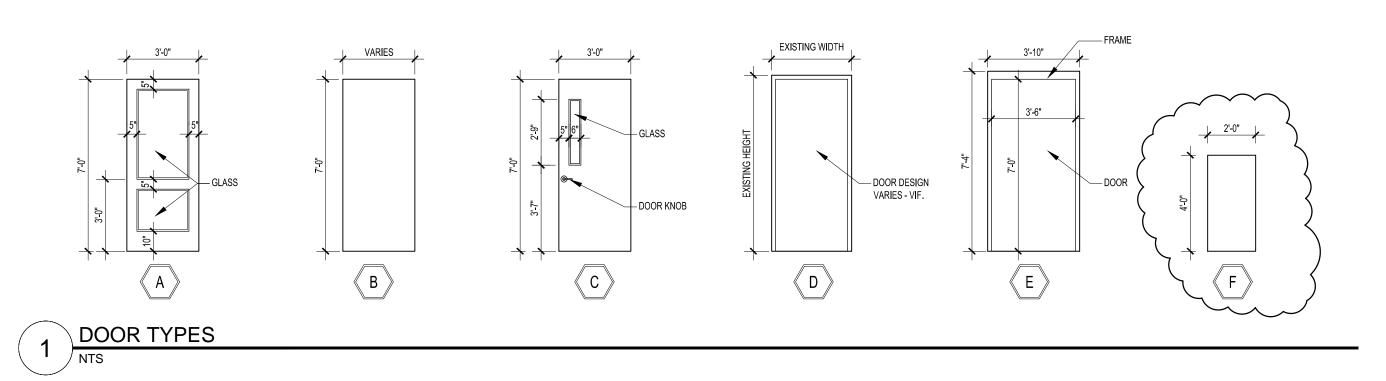

D·R·A

Drummey STUDIO 205
Rosane 225 OAKLAND ROAD
SOUTH WINDSOR,CT
06074

Planning phone: 860-644-8300
Architecture fax: 860-644-8301
Interior Design info@draws.com


GREAT
BARRINGTON RAMSDELL
LIBRARY

GREAT BARRINGTON, MASSACHUSETTS

PROGRESS PRINT APRIL 25.10

FOR REVIEW ONLY 11-17-23

KEY PLAN

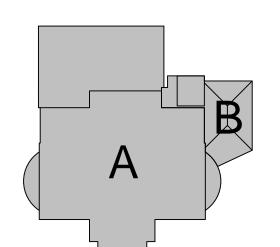



DOOR, WINDOW, HOLLOW METAL, STOREFRONT AND FINISH SCHEDULES

Scale: AS NOTED
Job No.: 09013.00
Drawn by: DRA

Date: **April 25, 2010**

A-6.1